




8.6

Erosion & Sediment Control Plan

The risks and mitigation measures for sediment and erosion controls have been outlined in section 5.2.5.

Further to this, we will be implementing sediment and erosion controls in accordance with the Sediment and Erosion Management Plan and the NSW Government "Blue Book" ["Managing Urban Stormwater | Soils and Construction_ Vol.1 (March 2004)"].

Please refer below to the site sediment and erosion control plan throughout the construction phase of the works.

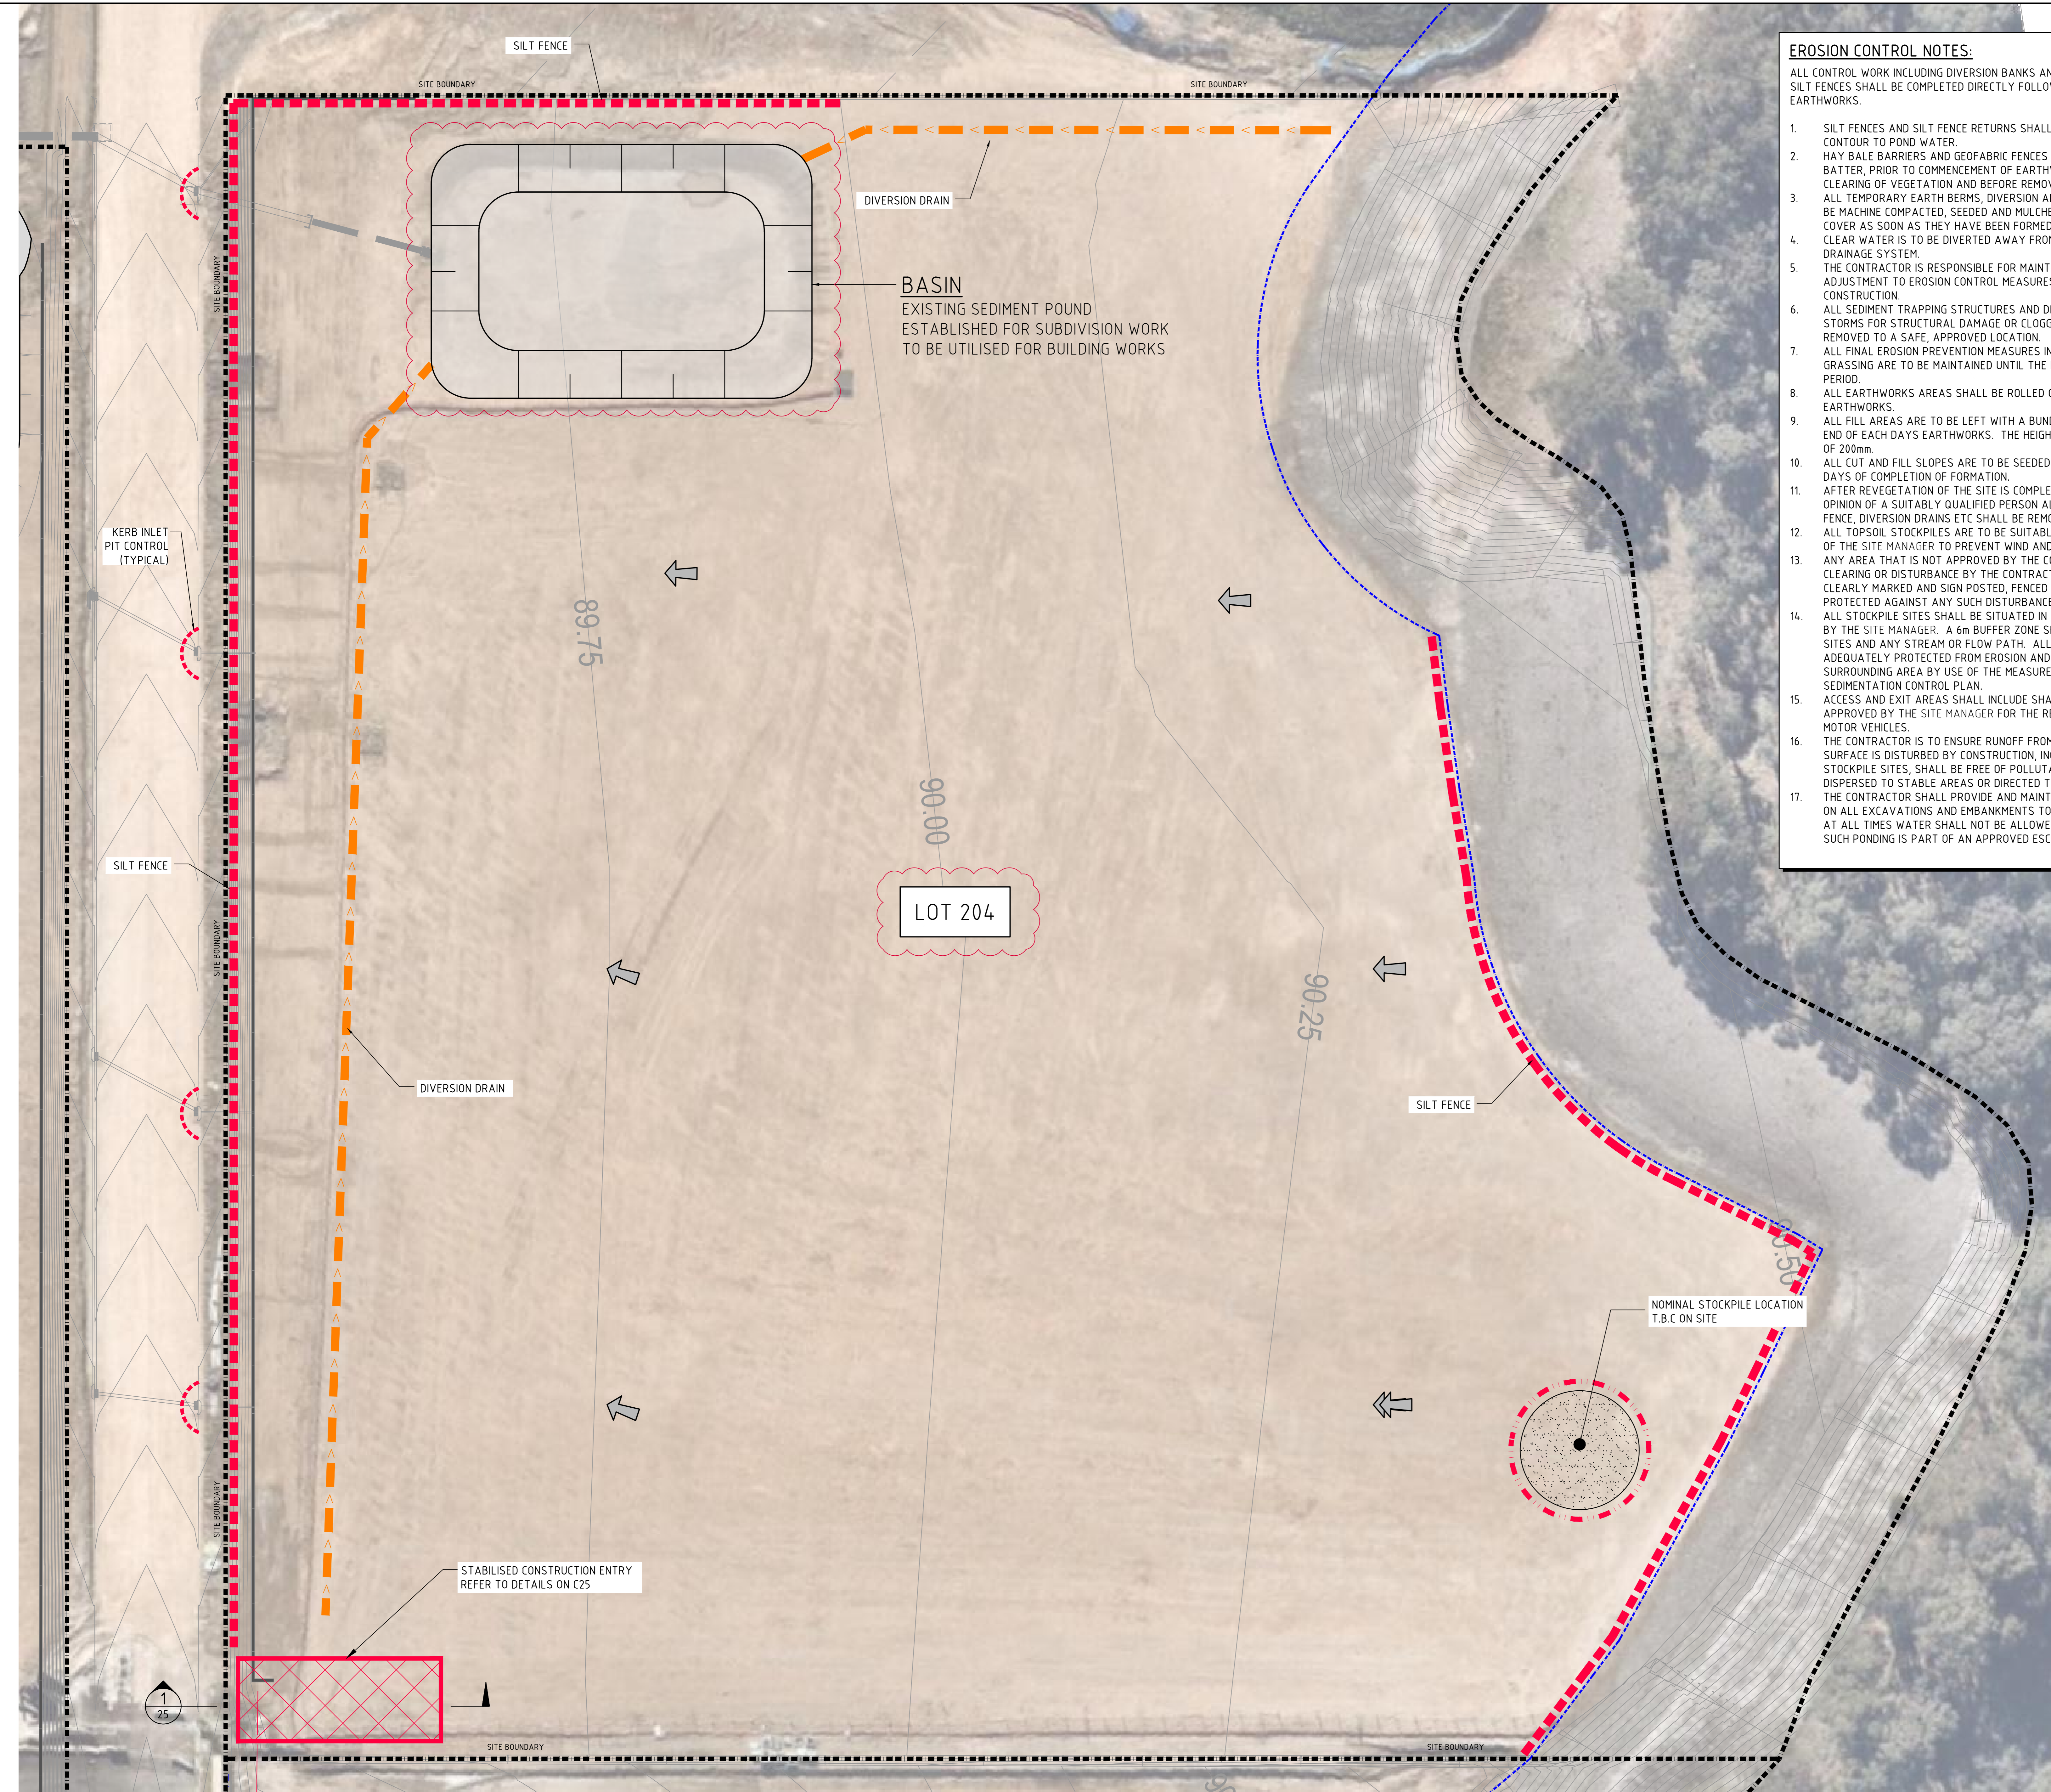

EROSION CONTROL NOTES:

ALL CONTROL WORK INCLUDING DIVERSION BANKS AND CATCH DRAINS, V-DRAINS AND SILT FENCES SHALL BE COMPLETED DIRECTLY FOLLOWING THE COMPLETION OF THE EARTHWORKS.

- SILT FENCES AND SILT FENCE RETURNS SHALL BE ERECTED CONVEX TO THE CONTOUR TO POND WATER.
- HAY BALE BARRIERS AND GEOTEXTILE FENCES ARE TO BE CONSTRUCTED TO TOE OF BATTER, PRIOR TO COMMENCEMENT OF EARTHWORKS, IMMEDIATELY AFTER CLEARING OF VEGETATION AND BEFORE REMOVAL OF TOP SOIL.
- ALL TEMPORARY EARTH BERMS, DIVERSION AND SILT DAM EMBANKMENTS ARE TO BE MACHINE COMPACTED, SEEDED AND MULCHED FOR TEMPORARY VEGETATION COVER AS SOON AS THEY HAVE BEEN FORMED.
- CLEAR WATER IS TO BE DIVERTED AWAY FROM DISTURBED GROUND AND INTO THE DRAINAGE SYSTEM.
- THE CONTRACTOR IS RESPONSIBLE FOR MAINTAINING AND PROVIDING ON GOING ADJUSTMENT TO EROSION CONTROL MEASURES AS REQUIRED DURING CONSTRUCTION.
- ALL SEDIMENT TRAPPING STRUCTURES AND DEVICES ARE TO BE INSPECTED AFTER STORMS FOR STRUCTURAL DAMAGE OR CLOGGING, TRAPPED MATERIAL IS TO BE REMOVED TO A SAFE, APPROVED LOCATION.
- ALL FINAL EROSION PREVENTION MEASURES INCLUDING THE ESTABLISHMENT OF GRASSING ARE TO BE MAINTAINED UNTIL THE END OF THE DEFECTS LIABILITY PERIOD.
- ALL EARTHWORKS AREAS SHALL BE ROLLED ON A REGULAR BASIS TO SEAL THE EARTHWORKS.
- ALL FILL AREAS ARE TO BE LEFT WITH A BUND AT THE TOP OF THE SLOPE AT THE END OF EACH DAYS EARTHWORKS. THE HEIGHT OF THE BUND SHALL BE A MINIMUM OF 200mm.
- ALL CUT AND FILL SLOPES ARE TO BE SEEDED AND HYDROMULCHED WITHIN 10 DAYS OF COMPLETION OF FORMATION.
- AFTER REVEGETATION OF THE SITE IS COMPLETE AND THE SITE IS STABLE IN THE OPINION OF A SUITABLY QUALIFIED PERSON ALL TEMPORARY WORK SUCH AS SILT FENCE, DIVERSION DRAINS ETC SHALL BE REMOVED.
- ALL TOPSOIL STOCKPILES ARE TO BE SUITABLY COVERED TO THE SATISFACTION OF THE SITE MANAGER TO PREVENT WIND AND WATER EROSION.
- ANY AREA THAT IS NOT APPROVED BY THE CONTRACT ADMINISTRATOR FOR CLEARING OR DISTURBANCE BY THE CONTRACTOR'S ACTIVITIES SHALL BE CLEARLY MARKED AND SIGN POSTED, FENCED OFF OR OTHERWISE APPROPRIATELY PROTECTED AGAINST ANY SUCH DISTURBANCE.
- ALL STOCKPILE SITES SHALL BE SITUATED IN AREAS APPROVED FOR SUCH USE BY THE SITE MANAGER. A 6m BUFFER ZONE SHALL EXIST BETWEEN STOCKPILE SITES AND ANY STREAM OR FLOW PATH. ALL STOCKPILES SHALL BE ADEQUATELY PROTECTED FROM EROSION AND CONTAMINATION OF THE SURROUNDING AREA BY USE OF THE MEASURES APPROVED IN THE EROSION AND SEDIMENTATION CONTROL PLAN.
- ACCESS AND EXIT AREAS SHALL INCLUDE SHAKE-DOWN OR OTHER METHODS APPROVED BY THE SITE MANAGER FOR THE REMOVAL OF SOIL MATERIALS FROM MOTOR VEHICLES.
- THE CONTRACTOR IS TO ENSURE RUNOFF FROM ALL AREAS WHERE THE NATURAL SURFACE IS DISTURBED BY CONSTRUCTION, INCLUDING ACCESS ROADS, DEPOT AND STOCKPILE SITES, SHALL BE FREE OF POLLUTANTS BEFORE IT IS EITHER DISPERSED TO STABLE AREAS OR DIRECTED TO NATURAL WATERCOURSES.
- THE CONTRACTOR SHALL PROVIDE AND MAINTAIN SLOPES, CROWNS AND DRAINS ON ALL EXCAVATIONS AND EMBANKMENTS TO ENSURE SATISFACTORY DRAINAGE AT ALL TIMES WATER SHALL NOT BE ALLOWED TO POND ON THE WORKS UNLESS SUCH PONDING IS PART OF AN APPROVED ESCP / SWMP.

SEDIMENTATION BASIN NOTE:

FOR SEDIMENT & EROSION CONTROL DETAILS REFER TO DRAWING C012990.05-SSDAMOD25.

SEDIMENTATION BASIN SIZING BASED ON RECOMMENDATIONS OF 'SOILS AND CONSTRUCTION, MANAGING URBAN STORMWATER-THE BLUE BOOK'. CAPACITY BASED UPON 5 DAY RAINFALL DEPTH AT 85th PERCENTILE INTENSITY FOR FAIRFIELD (315mm).

SEDIMENTATION BASIN:
 CATCHMENT AREA = 4.03ha
 REQUIRED BASIN VOLUME = 1,270m³
 BASE DIMENSION (LxB) = 20.0m x 36.0m
 TOP DIMENSION (LxB) = 32.0m x 4.8.0m
 MAX SIDE SLOPE = 1V:3H
 DEPTH = 2.0m
 PROVIDED BASIN VOLUME = 2,205m³

SEDIMENTATION BASINS TO COLLECT RUN-OFF IN EXTREME RAINFALL EVENTS. COLLECTED RUN-OFF TO BE ASSESSED BY A QUALIFIED LABORATORY FOR DOUSING RATES OF ALUM OR GYPSUM TO ENSURE COAGULATION OF SEDIMENTS PRIOR TO WATER BEING DISCHARGED TO COUNCIL STORMWATER SYSTEM.

EACH BASIN IS TO HAVE A MARKER PLACED AS PER THE DETAIL TO INDICATE WHEN SEDIMENT IS TO BE REMOVED. REMOVED SEDIMENT IS TO BE CLASSED AND Dewatered PRIOR TO REMOVAL FROM SITE.

ALLOWANCE TO BE MADE DURING BENCHING OF SITE TO ENSURE RUN-OFF IS DIRECTED TO SEDIMENTATION BASINS.



NOTES:

- ASSUME TYPE D SOIL (CLAY/SILTY CLAY)
- ASSUME GROUP D SOIL (HIGH PLASTICITY AND SHRINK/SWELL PROPERTIES)
- C_v = 0.5 & LENGTH TO WIDTH RATIO OF 2 (MIN)

SOIL TYPE TO BE ASSESSED BY A GEOTECHNICAL ENGINEER

POND DEWATERING NOTES:

- DRAIN PONDS OF WATER & DISCHARGE CLEAN WATER TO STORMWATER DRAINAGE SYSTEM (AS PER NOTES 2 & 3) - REFER TO STORMWATER PLAN FOR LOCATIONS.
- DEWATERING TO BE PERFORMED IN SUCH A MANNER AS TO REMOVE CLEAN WATER WITHOUT REMOVING OR DISTURBING SILT, SEDIMENT OR OTHER ORGANIC MATERIAL FROM THE BASE OF THE PONDS.
- DISCHARGE OF WATER FROM PONDS TO HAVE A PH RANGE OF 6.5-8.5 AND TSS < 50mg/L. PONDS TO BE DOSED WITH GYPSUM (APPROX. 30mg PER CUBIC METRE) TO ACCELERATE SETTLEMENT OF SUSPENDED SOLIDS.
- REMOVE ALL SILT, ORGANIC AND WATER LOGGED MATERIAL FROM BASE OF POND (NOM. DEPTH 0.5-1.0m) AND DISPOSE OF IN ACCORDANCE WITH THE ACCEPTABLE PRACTICE.
- EXPOSE NATURAL SITE SOILS AND COMPACT SUBGRADE IN ACCORDANCE WITH THE SITE PREPARATION NOTES (REFER DRG. SSDA10) REMOVING ANY SOFT ZONES AS REQ'D.
- PLACE AND COMPACT FILL AS PER SITE PREPARATION NOTES ON DRAWING SSDA10.
- INFORMATION PROVIDED ON THIS DRAWING SHALL BE USED TO GUIDE THE DEVELOPMENT OF THE CONSTRUCTION ENVIRONMENTAL MANAGEMENT PLAN THAT SHALL BE IMPLEMENTED DURING CONSTRUCTION.

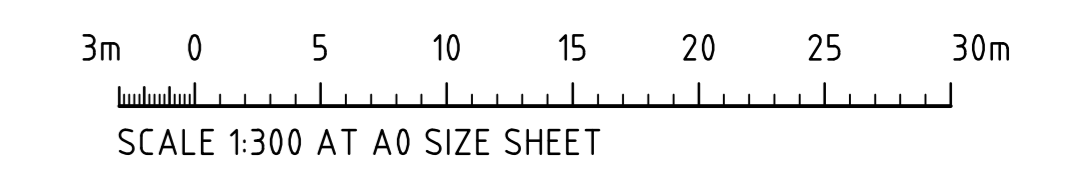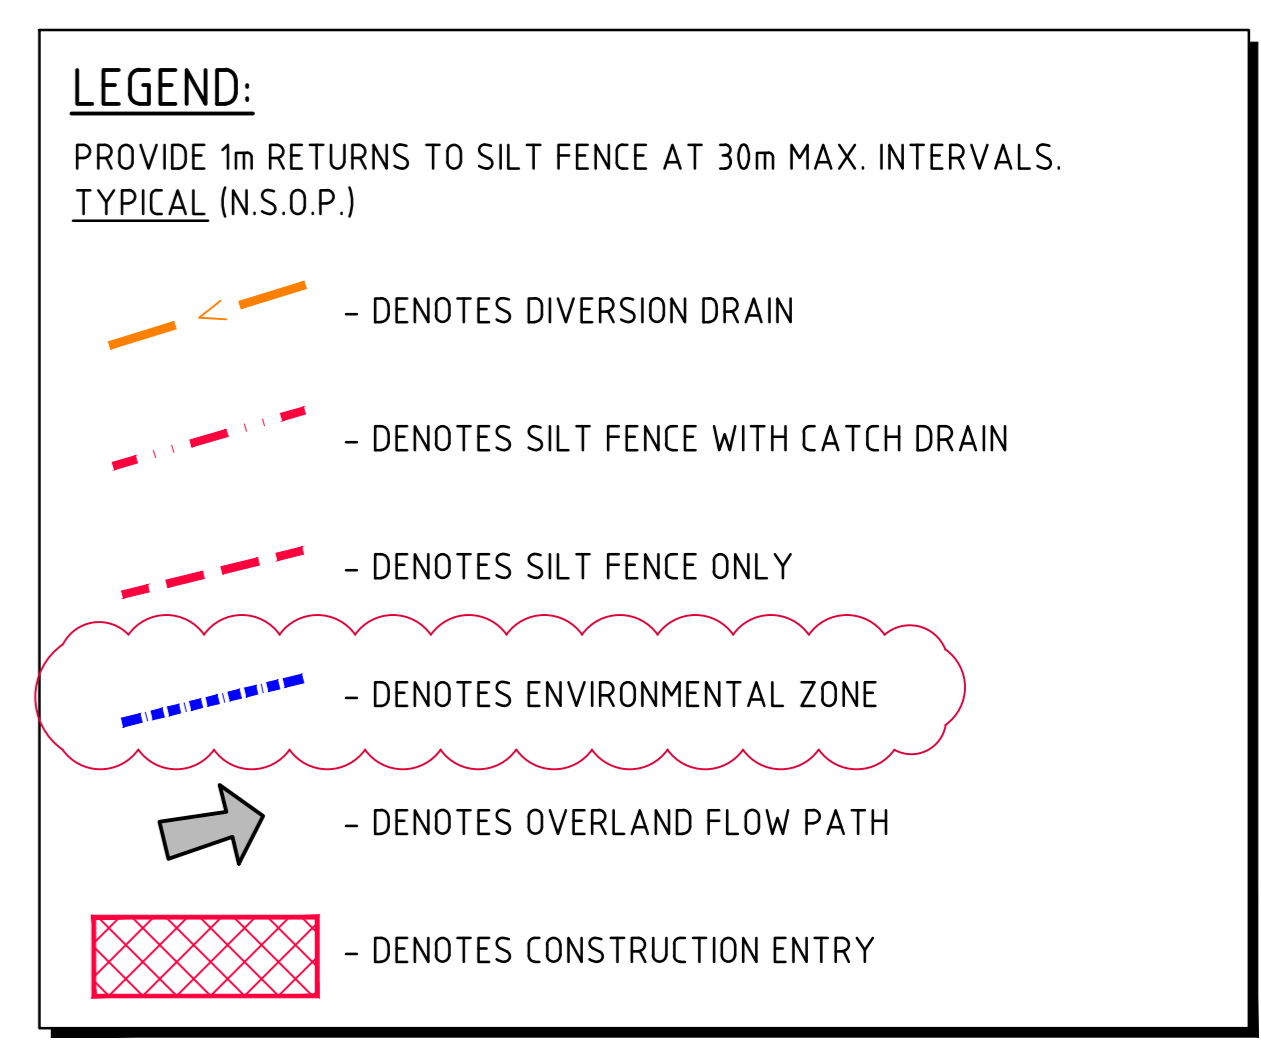

EROSION SEDIMENT CONTROL PLAN
SCALE 1:300

PRELIMINARY ONLY

ISSUED FOR PRELIMINARY ONLY	93.09.21	B
ISSUED FOR PRELIMINARY ONLY	20.08.21	A
AMENDMENTS	DATE	ISSUE

AMENDMENTS	DATE	ISSUE	AMENDMENTS	DATE	ISSUE
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ARCHITECT

CLIENT

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DRAWING TITLE
EROSION SEDIMENT CONTROL PLAN
 DRAWING No. **C012990.05-SSDAMOD20** ISSUE **B**