EXPOSURE OR GUARD RAIL DESIGN LOAD UNINHABITABLE ATTICE WITHOUT STORAGE UNINHABITABLE ATTICE WITH LIMITED STORAGE HABITABLE ATTICE & ATTICE WITH FIXED STAIRS BALCONIES (EXTERIOR) & DECKS SLEEPING ROOMS SNOW LOAD

NOMINAL WIND SPEED

ULTIMATE DESIGN WIND SPEED 9' 1-1/2" 9' 1-1/2" WINDOW HEIGHT WINDOW HEIGHT HED SECOND FLOOR 20 PSF 10 PSF 25 PSF 90 MPH 115 MPH 200 PLF (10 PSF 20 PSF 30 PSF 40 PSF 40 PSF (R301.5) RAILINGS OMITTED FOR CLARITY INSTALL RAILINGS AS REQ'D PER R312.1 SQUARE FOOTAGE
FIRST FLOOR
SECOND FLOOR
GARAGE
FRONT PORCH
DECK RONT EVATION 1500 1100 477 295 183 \$0. \$0. \$0. FRONT FOUND, FIRST F SECONI ELEVATI WALL BI NT ELEVATION / NOTES
NDATION / SECTIONS
I FLOOR PLAN / SECTION
OND FLOOR PLAN / SECTION / ROOF PLAN
ATIONS
BRACING ONTENT CULTURED STONE VENEER (TYP)
SEE ELEVATIONS <u>- 420</u>

-THESE DRAWINGS ARE DIAGRAMMATIC INTENDED TO OUTLINE GENERAL REQUIREMENTS ONLY AND NOT INTENDED TO BE COMPLETE IN ALL DETAILS. SPECIFIC IMPLEMENTATIONS OF THE PLANS SHALL BE THE RESPONSIBILITY OF THE CONTRACTOR WHO REPRESENTS HE HAS THE SKILLS AND EXPERT KNOWLEDGE TO EXECUTE THE WORK REQUIRED.

ROOF LIVE LOAD ROOF DEAD LOAD

DESIGN LOADS:

-THE CONTRACTOR AND EACH SUBCONTRACTOR SHALL BE REQUIRED TO CHECK AND VERIFY THAT PLANS CON LOCAL ORDINANCES, BUILDING CODES AND MANUFACTURERS RECOMMENDATIONS PRIOR TO BEGINNING WORI FORM TO

THE CONTRACTOR AND EACH SUBCONTRACTOR SHALL CONFORM TO ALL STATE AND LOCAL CODES AND ORDINANCES

-MEASUREMENTS AND WORKING CONDITIONS FOR ALL WORK SHALL BE TAKEN AT THE SITE AND COORDINATED WITH CONNECTIONS WORKS BY EACH SUBCONTRACTOR

-ANY WORK NOT DIRECTLY SHOWN ON THE DRAWINGS OR LISTED IN THE SPECIFICATIONS (IF APPROVED), BUT ARE IMPLIED OR OTHERWISE NORMALLY CONSIDERED PART OR A SUCCESSFUL INSTALLATION, SHALL BE REQUIRED AND CONSIDERED AN INTEGRAL PART OF THIS WORK

-THE CONTRACTOR AND EACH SUBCONTRACTOR SHALL VERIFY ALL SITE CONDITIONS, DIMENSIONS AND DETAIL LAYING OUT OR PROCEEDING WITH WORK AND SHALL BE HELD ACCOUNTABLE FOR ANY ERROR RESULTING FR VERIFICATION ILS SHOWN IN THE DRAWINGS BEFORE OM FAILURE TO EXERCISE SUCH

-ANY MODIFICATIONS TO THE DRAWINGS OR CHANGES TO THE CONSTRUCTION ON SITE SHALL BE CHECKED FOR AFFECT TO OTHER AREAS AND VERIFIED WITH THE CONTRACTOR BEFORE PROCEEDING WITH THE WORK

THE CONTRACTOR AND EACH SUBCONTRACTOR SHALL FURNISH ALL LABOR, MATERIALS, EQUIPMENT AND SERVICES FOR PROPER INSTALLATION WORK SHALL BE DONE BY SKILLED MECHANICS IN ACCORDANCE WITH THE BEST PRACTICE FOR A SUBSTANTIAL AND COMPLETE JOB

-SOIL BEARING CAPACITY IS ASSUMED TO BE 1500PSF MIN. WITH FOOTING PLACED ON UNDISTURBED EARTH, AND SLAB ON COMPACTED FILL WITH 95 DRY DENSITY

-ALL ENGINEERED LUMBER SUCH AS LAMINATED VENEER LUMBER, ROOF TRUSSES, FLOOR TRUSSES & I-JOIST ARE INDICATED AS STRUCTURAL MEMBERS. CONTRACTOR TO HAVE MANUFACTURER'S REPRESENTATIVE ISSUE CALCULATIONS FOR ALL ENGINEERED LUMBER TO THE BUILDING INSPECTIONS DEPARTMENT UPON APPLICATION OF BUILDING PERMIT

ROOFING CONTRACTOR TO INSTALL ICE AND WATER SHIELD ON ROOF TO EAVE 2'-0" INSIDE EXTERIOR WALL L

-MECHANICAL, ELECTRICAL AND PLUMBING INFORMATION PROVIDED BY OTHERS. THESE TRADES ARE RESPON USE PRESSURE TREATED LUMBER BAND BOARD AND SILL PLATE WHERE DECKS, PORCHES AND OTHER APPURTENANCES ARE ATTACHED SIBLE FOR THEIR OWN PERMITS

-VERIFY THAT FRAMING AND CONSTRUCTION DIMENSIONS ARE COORDINATED WITH SHOP DRAWINGS OF REQUIRED CASEWORK, HVAC EQUIPMENT, BATHTUBS OR OTHER FIXTURES AND EQUIPMENT PRIOR TO CONSTRUCTION, ORDERING AND INSULATION

5.7 SQUARE FEET, FOR GRADE FLOOR WINDOWS SHALL NOT BE GREATER THAN 44" ABOVE FIN.

-EXHAUST FAN AND CONDENSATE LINES SHALL BE RUN TO AN APPROVED EXTERIOR DISCHARGE

-PROVIDE GROUND TREATMENT THROUGHOUT

-ALL EXPOSED DECK & SCREENED PORCH LUMBER TO BE COMPOSITE OR PRESSURE TREATED

-INTERIOR PARTITIONS ARE ILLUSTRATED AS 3 ½" WALL STUDS @ 16" O.C. UNLESS INDICATED OTHERWISE

-WOOD ROOF TRUSSES SHALL BE DESIGNED AND MANUFACTURED BY A LOCAL TRUSS REGISTER IN THE COMMONWEALTH OF VIRGINIA. THE TRUSS MANUFACTURER SHALL SUPERVISING ENGINEER TO THE GENERAL CONTRACTOR FOR APPROVAL BEFORE BEGI

DRAWINGS DESIGNED VIRGINIA RESIDENTAL 2021

-PROTECT EXISTING CONSTRUCTION FROM DAMAGE RESULTING FROM ANY WORK DONE BY CONTRACTOR OR ANY SUBCONTRACTOR -CONTRACTOR SHALL CAULK, FLASH OR OTHERWISE MAKE THE BUILDING WEATHERTIGHT. SEAL ALL GAPS BETWEEN DISSIMILAR MATERIALS

-EACH SLEEPING ROOM SHALL HAVE AT LEAST ONE WINDOW WITH A MINIMUM NET CLEAR OPENING OF A MINIMUM NET CLEAR WIDTH AND HEIGHT DIMENSIONS OF 20" & 24" RESPECTIVELY. THE SILL HEIGHT:

-SMOKE DETECTORS SHALL BE INTERCONNECTED AND RECEIVE THEIR PRIMARY POWER BY PERMANENT SYSTEM AND WHEN PRIMARY POWER IS INTERRUPTED, SHALL RECEIVE POWER FROM A BATTERY

-BRIDGING AND BLOCKING ON ALL 8'-0" SPANS AND AT MIDPOINTS OF SPANS

-ALL DIMENSIONS ARE ACTUARIAL AND ARE SHOWN FROM FACE OF STUD OR FACE OF MASONRY UNLESS INDICATED OTHERWISE

-EXTERIOR FRAMED PARTITIONS ARE ILLUSTRATED AS 3 ½" WALL STUDS, ½" SHEATHING (4" TOTAL) UNLESS INDICATED OTHERWISE

TITLE: **NOTES** SCALE: 1/4" = 1'-0"

FRONT ELEVATION

DRAWN BY: MARK MOON LANEXA, VA 23089 804-366-2643 DATE: 6/25/24


DRAWN FOR: GCS CUSTOM HOME BUILDERS LLC 2025 EAST MAIN ST. SUITE 120 RICHMOND, VA 23223 804-690-3282


PROJECT NAME:


FOUR BEDROOM


NOTES 1. CONTRACTOR SHALL CONFORM TO THE VIRGINIA UNIFORM STATEWIDE BUILDING CODE AND ALL LOCAL ORDINANCES. 2. CONTRACTOR SHALL VERIFY ALL DIMENSIONS, MATERIAL SIZING, LOADS AND SITE CONDITIONS PRIOR TO STARTING

CONSTRUCTION

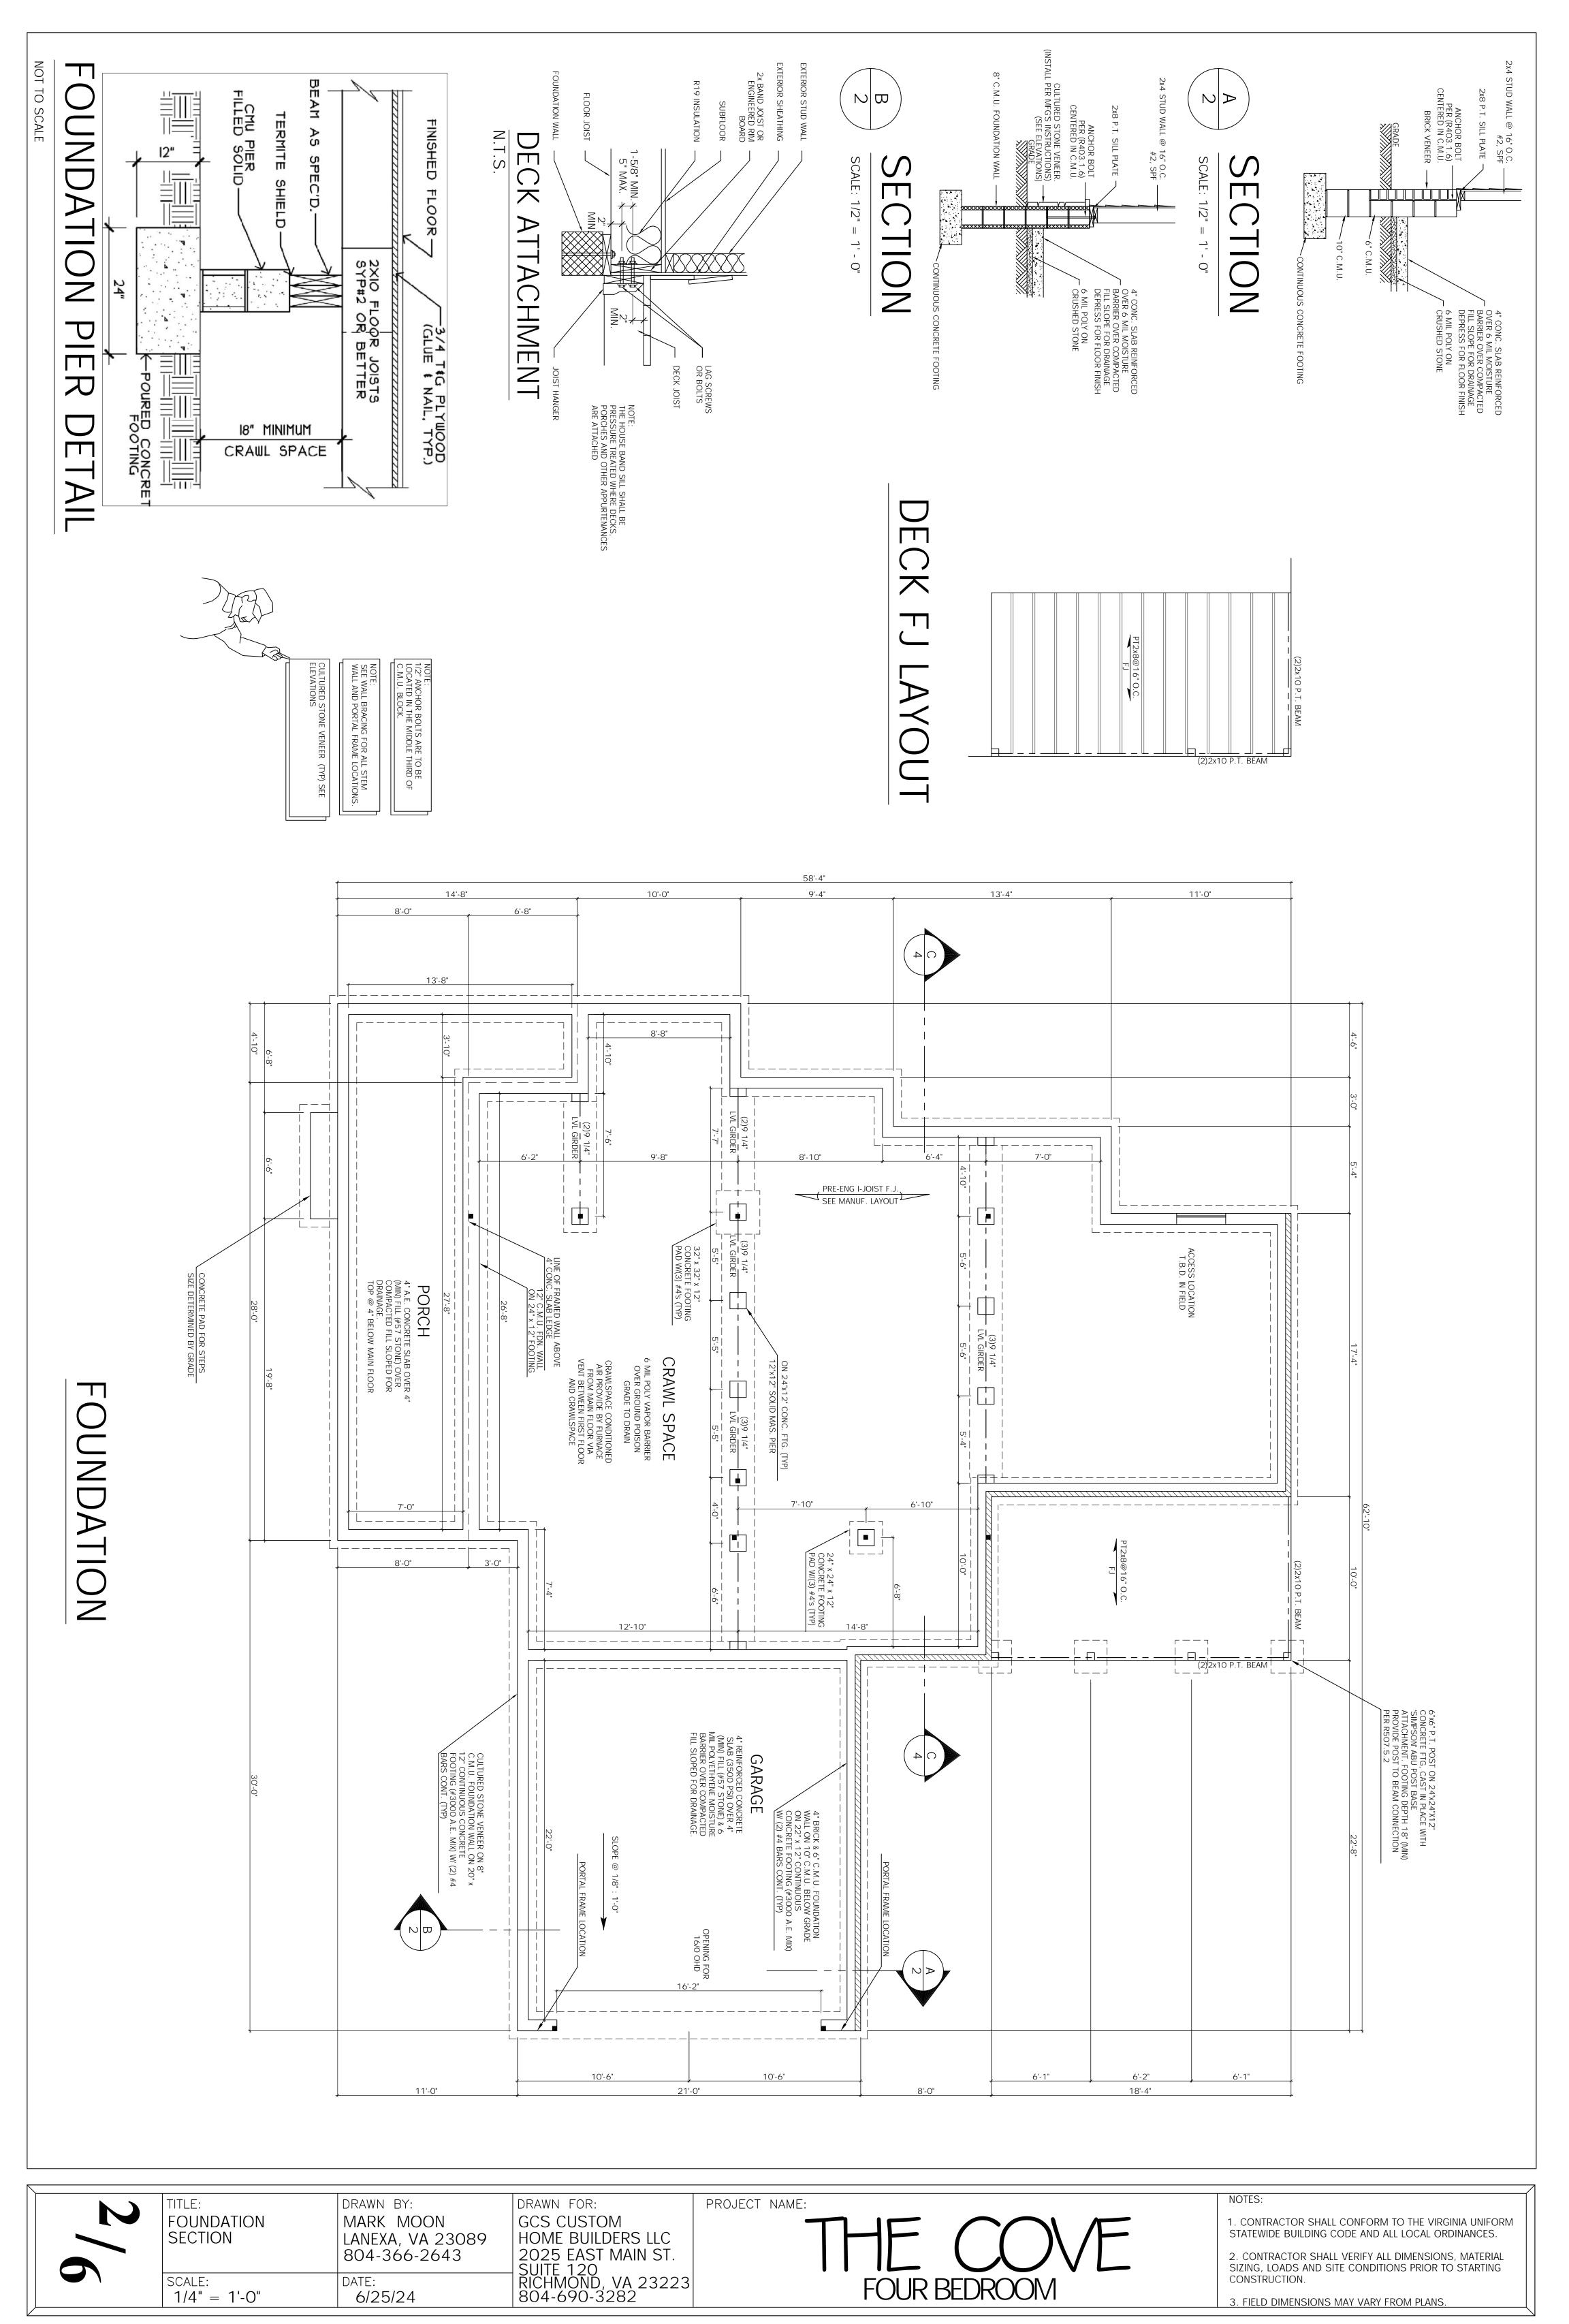

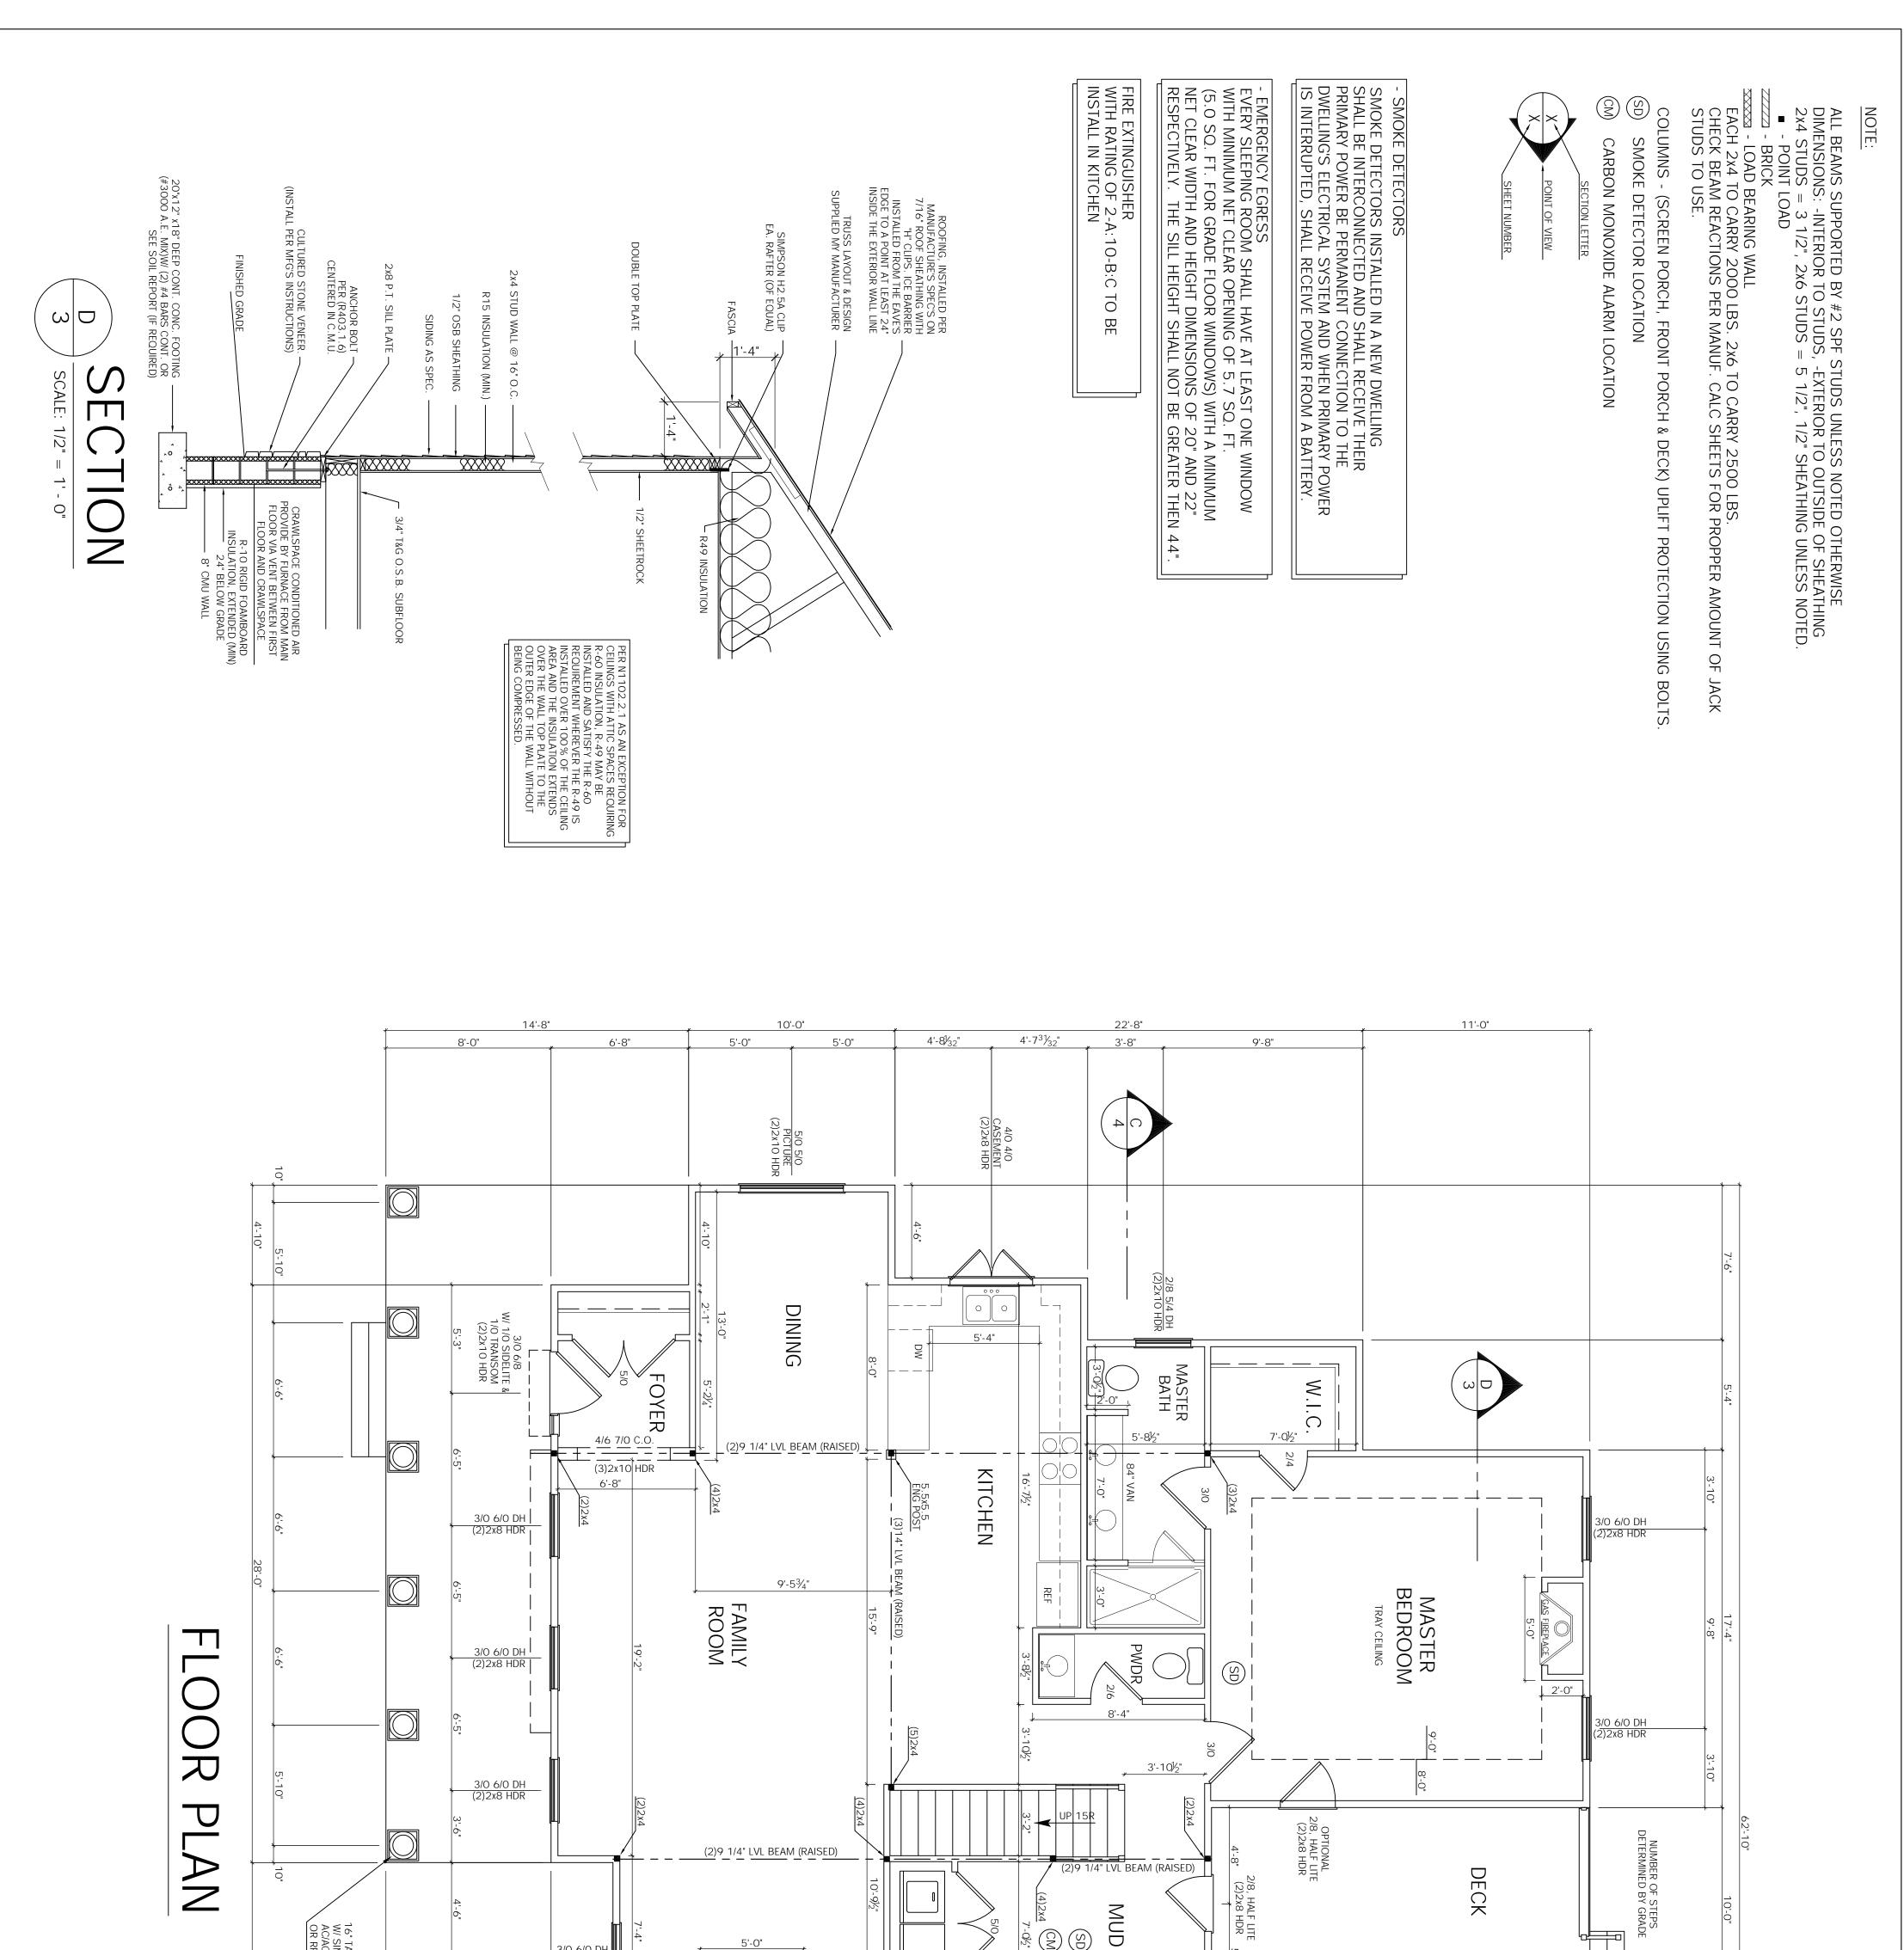

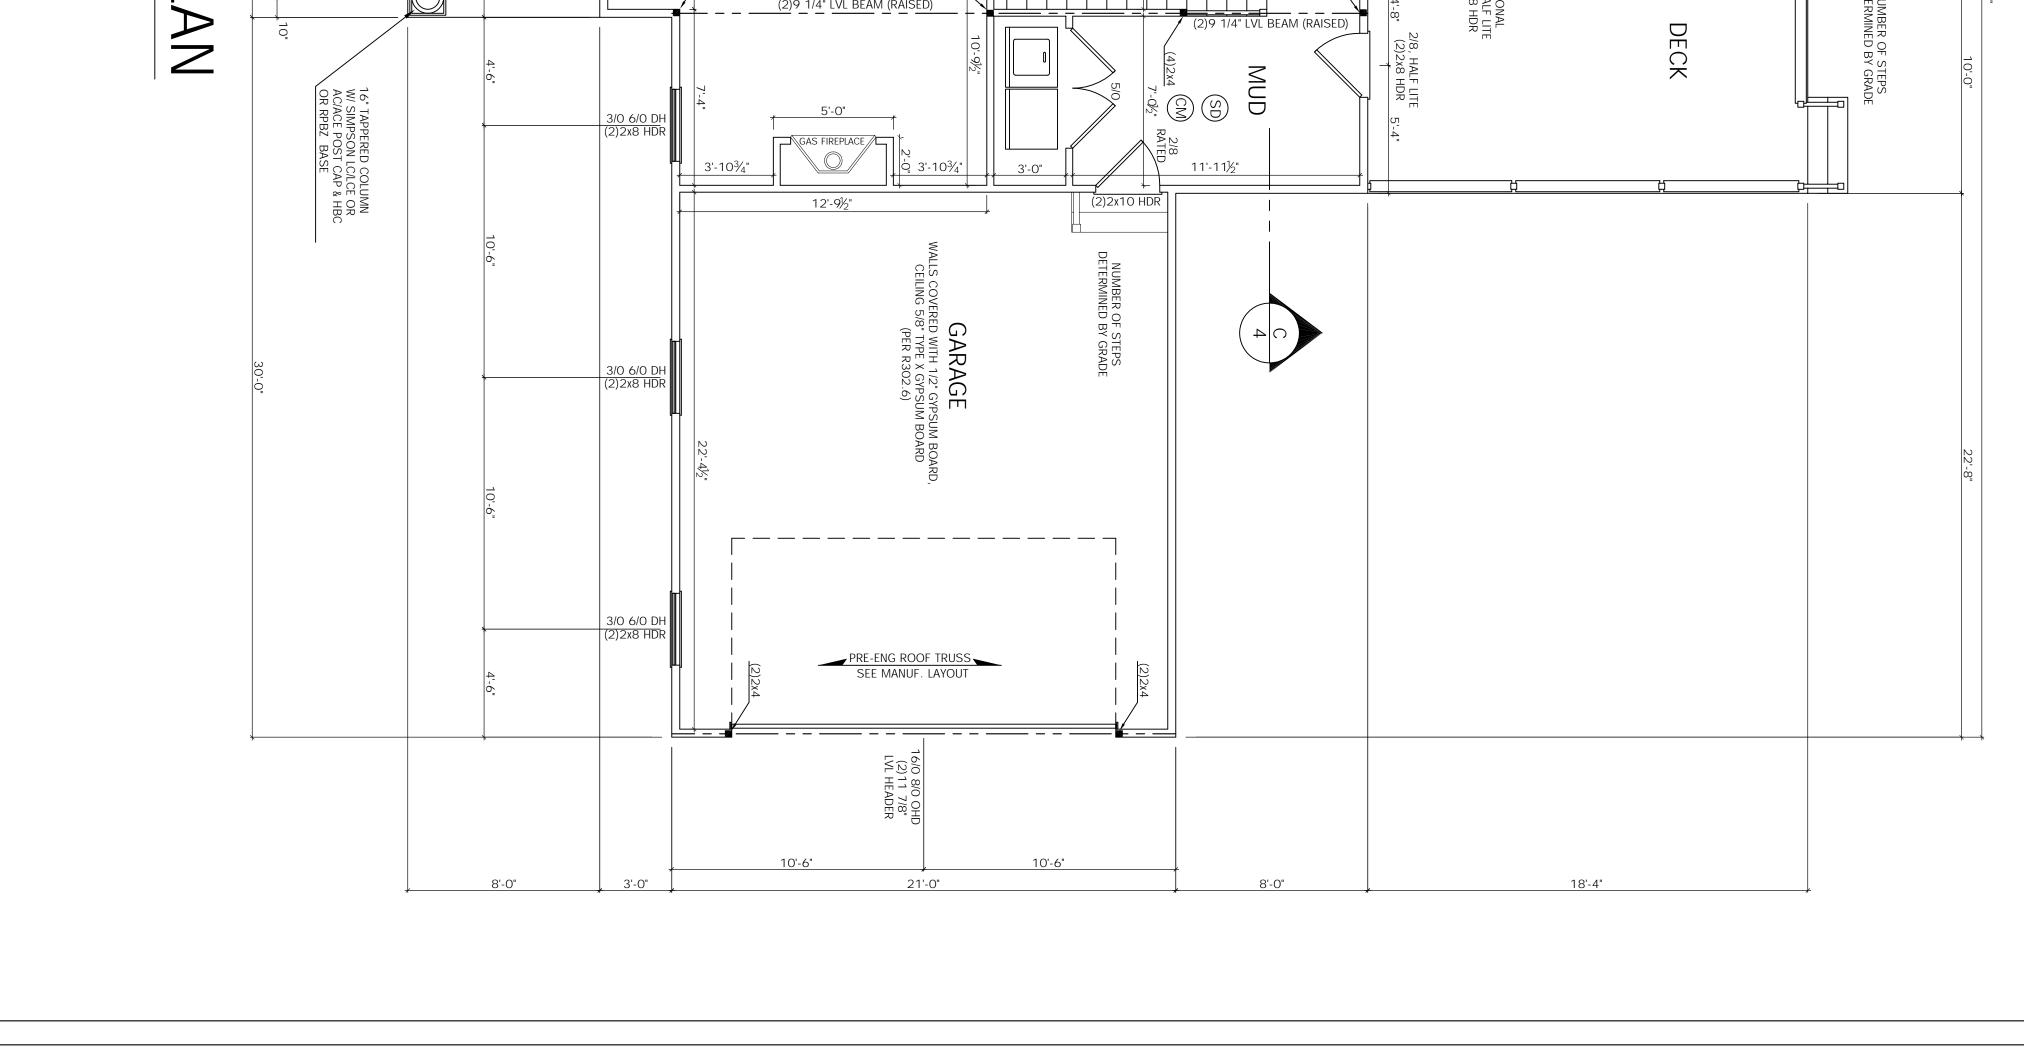

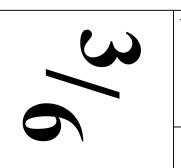

TITLE: DRAWN BY:

FIRST FLOOR
SECTION

SECTION

SCALE: DATE: 6/25/24

DRAWN FOR:
GCS CUSTOM
HOME BUILDERS LLC
2025 EAST MAIN ST.
SUITE 120
RICHMOND, VA 23223
804-690-3282


PROJECT NAME:

THE COVE
FOUR BEDROOM

NOTES:

 CONTRACTOR SHALL CONFORM TO THE VIRGINIA UNIFORM STATEWIDE BUILDING CODE AND ALL LOCAL ORDINANCES.
 CONTRACTOR SHALL VERIFY ALL DIMENSIONS, MATERIAL SIZING, LOADS AND SITE CONDITIONS PRIOR TO STARTING CONSTRUCTION.

3. FIELD DIMENSIONS MAY VARY FROM PLANS

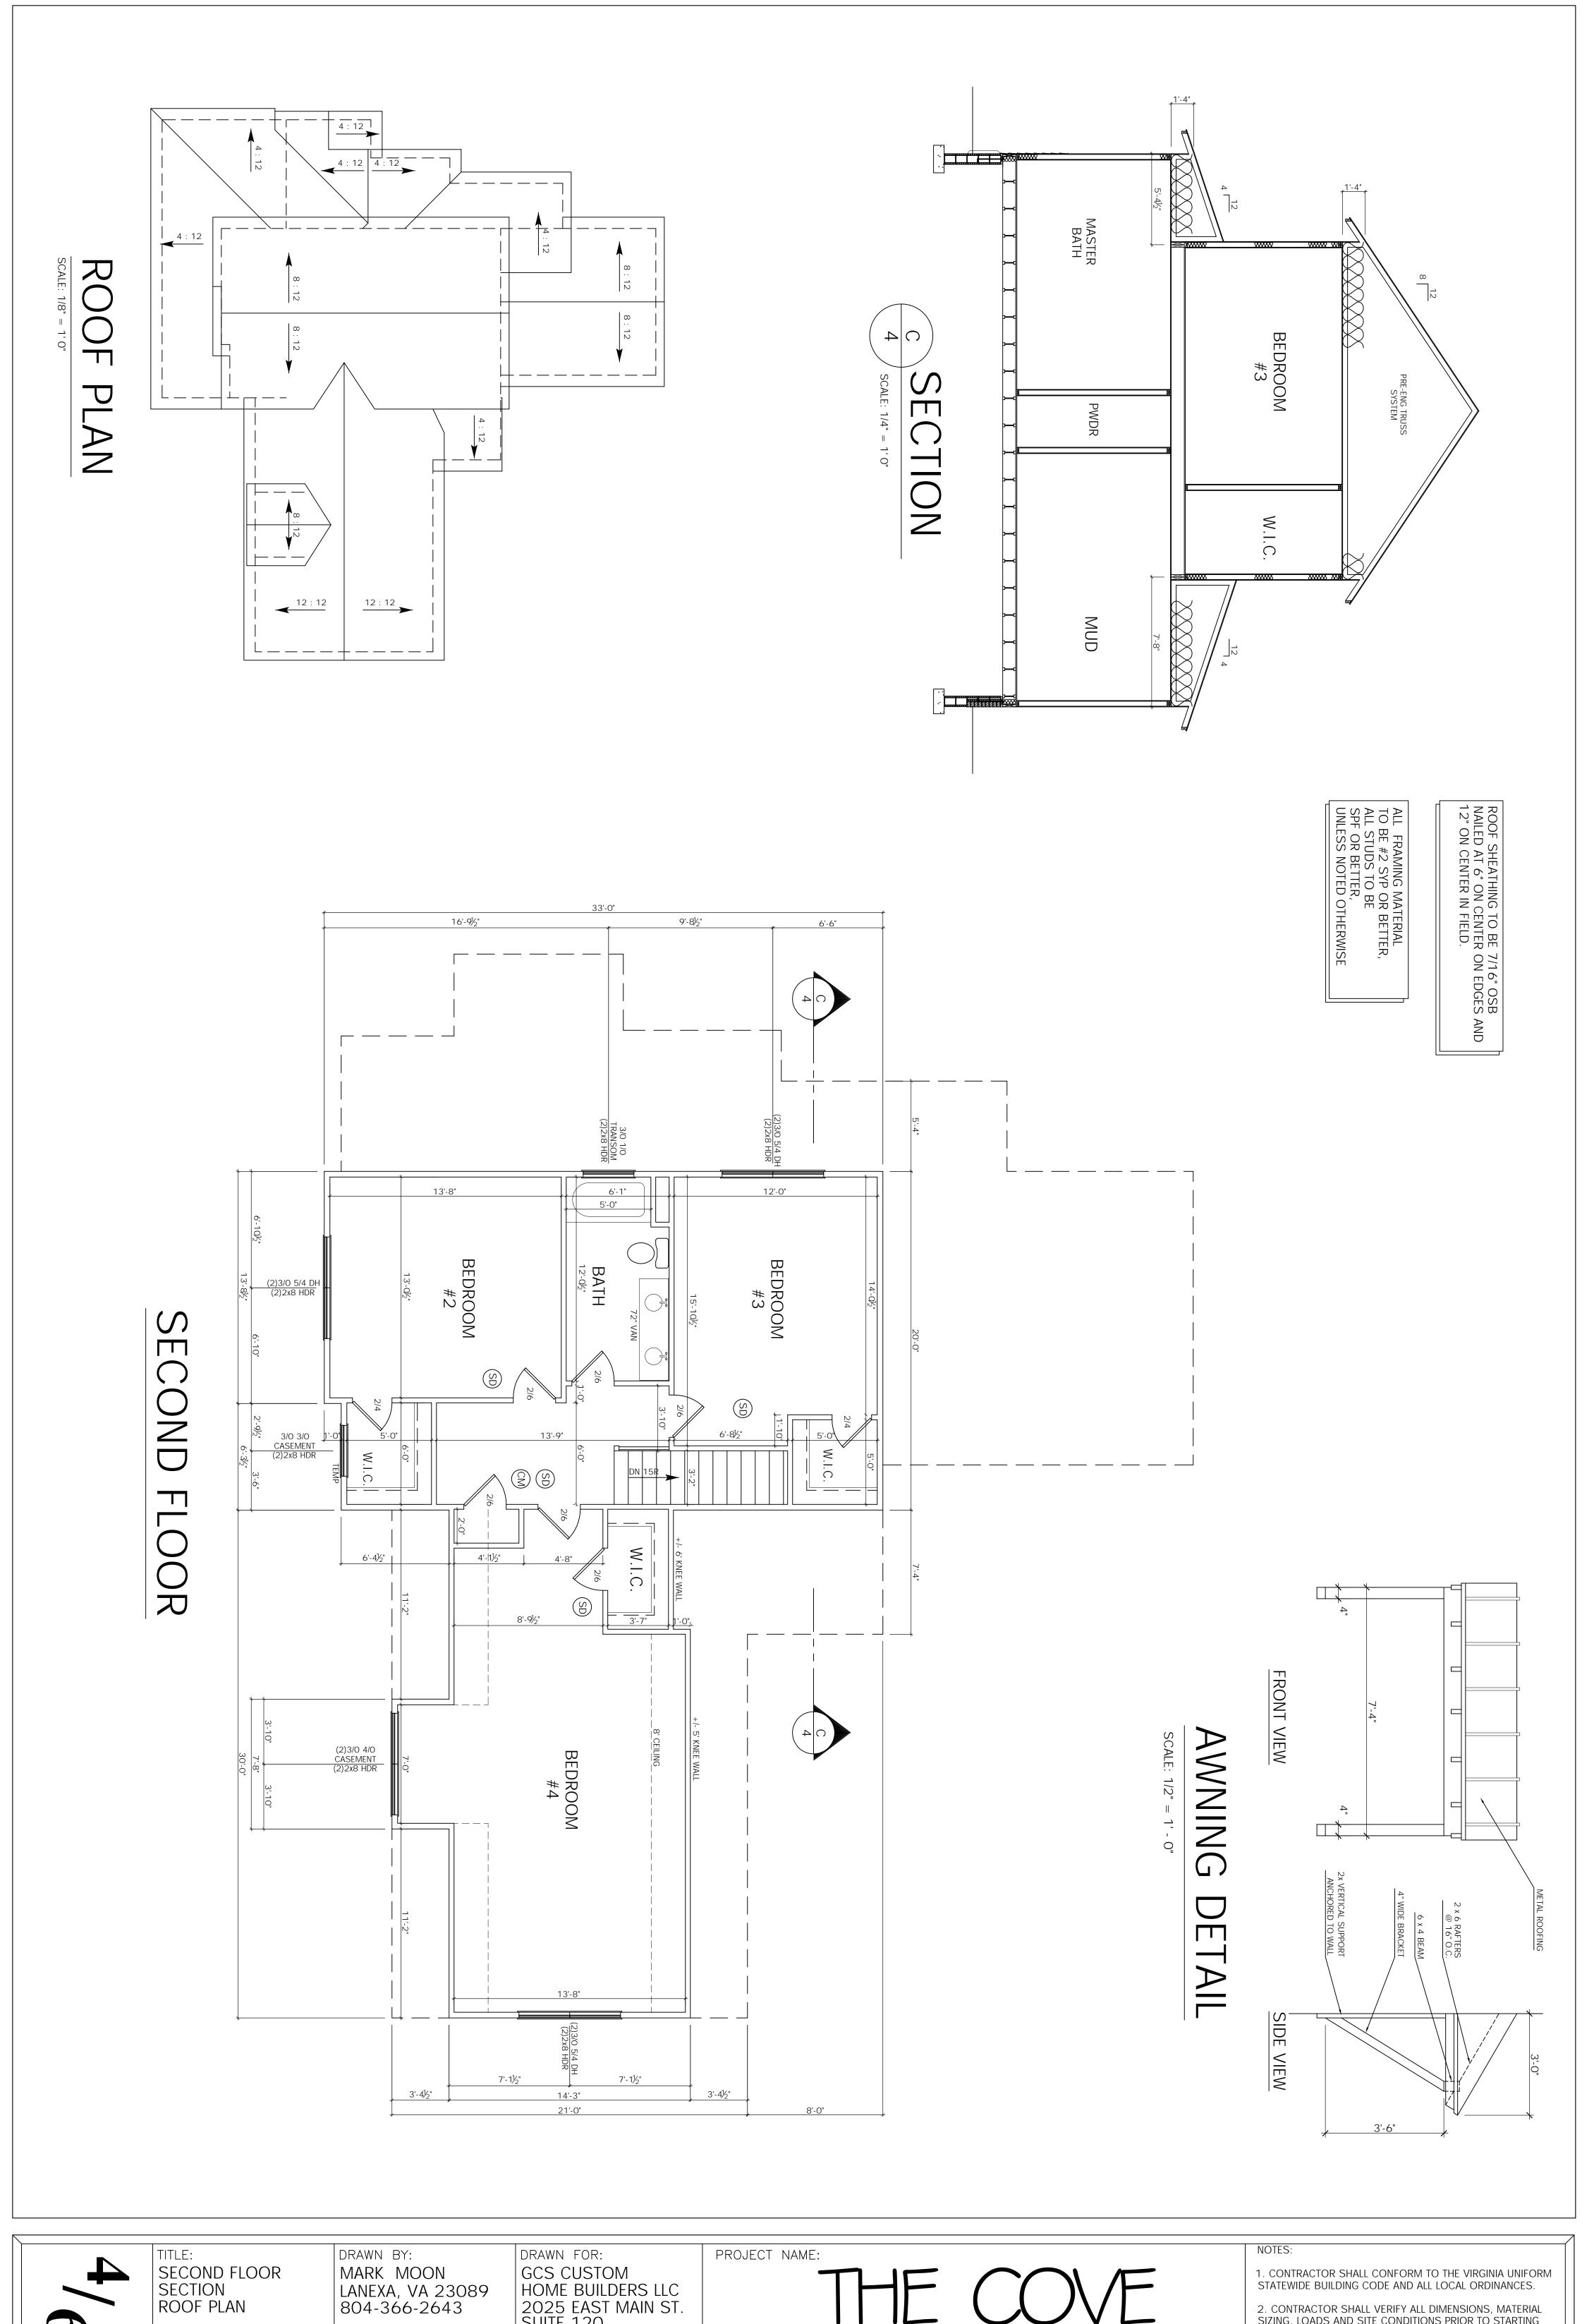




SCALE: DATE: 6/25/24 1/4" = 1'-0"

GCS CUSTOM
HOME BUILDERS LLC
2025 EAST MAIN ST.
SUITE 120
RICHMOND, VA 23223
804-690-3282

TE COVE
FOUR BEDROOM


2. CONTRACTOR SHALL VERIFY ALL DIMENSIONS, MATERIAL SIZING, LOADS AND SITE CONDITIONS PRIOR TO STARTING CONSTRUCTION.


3. FIELD DIMENSIONS MAY VARY FROM PLANS.

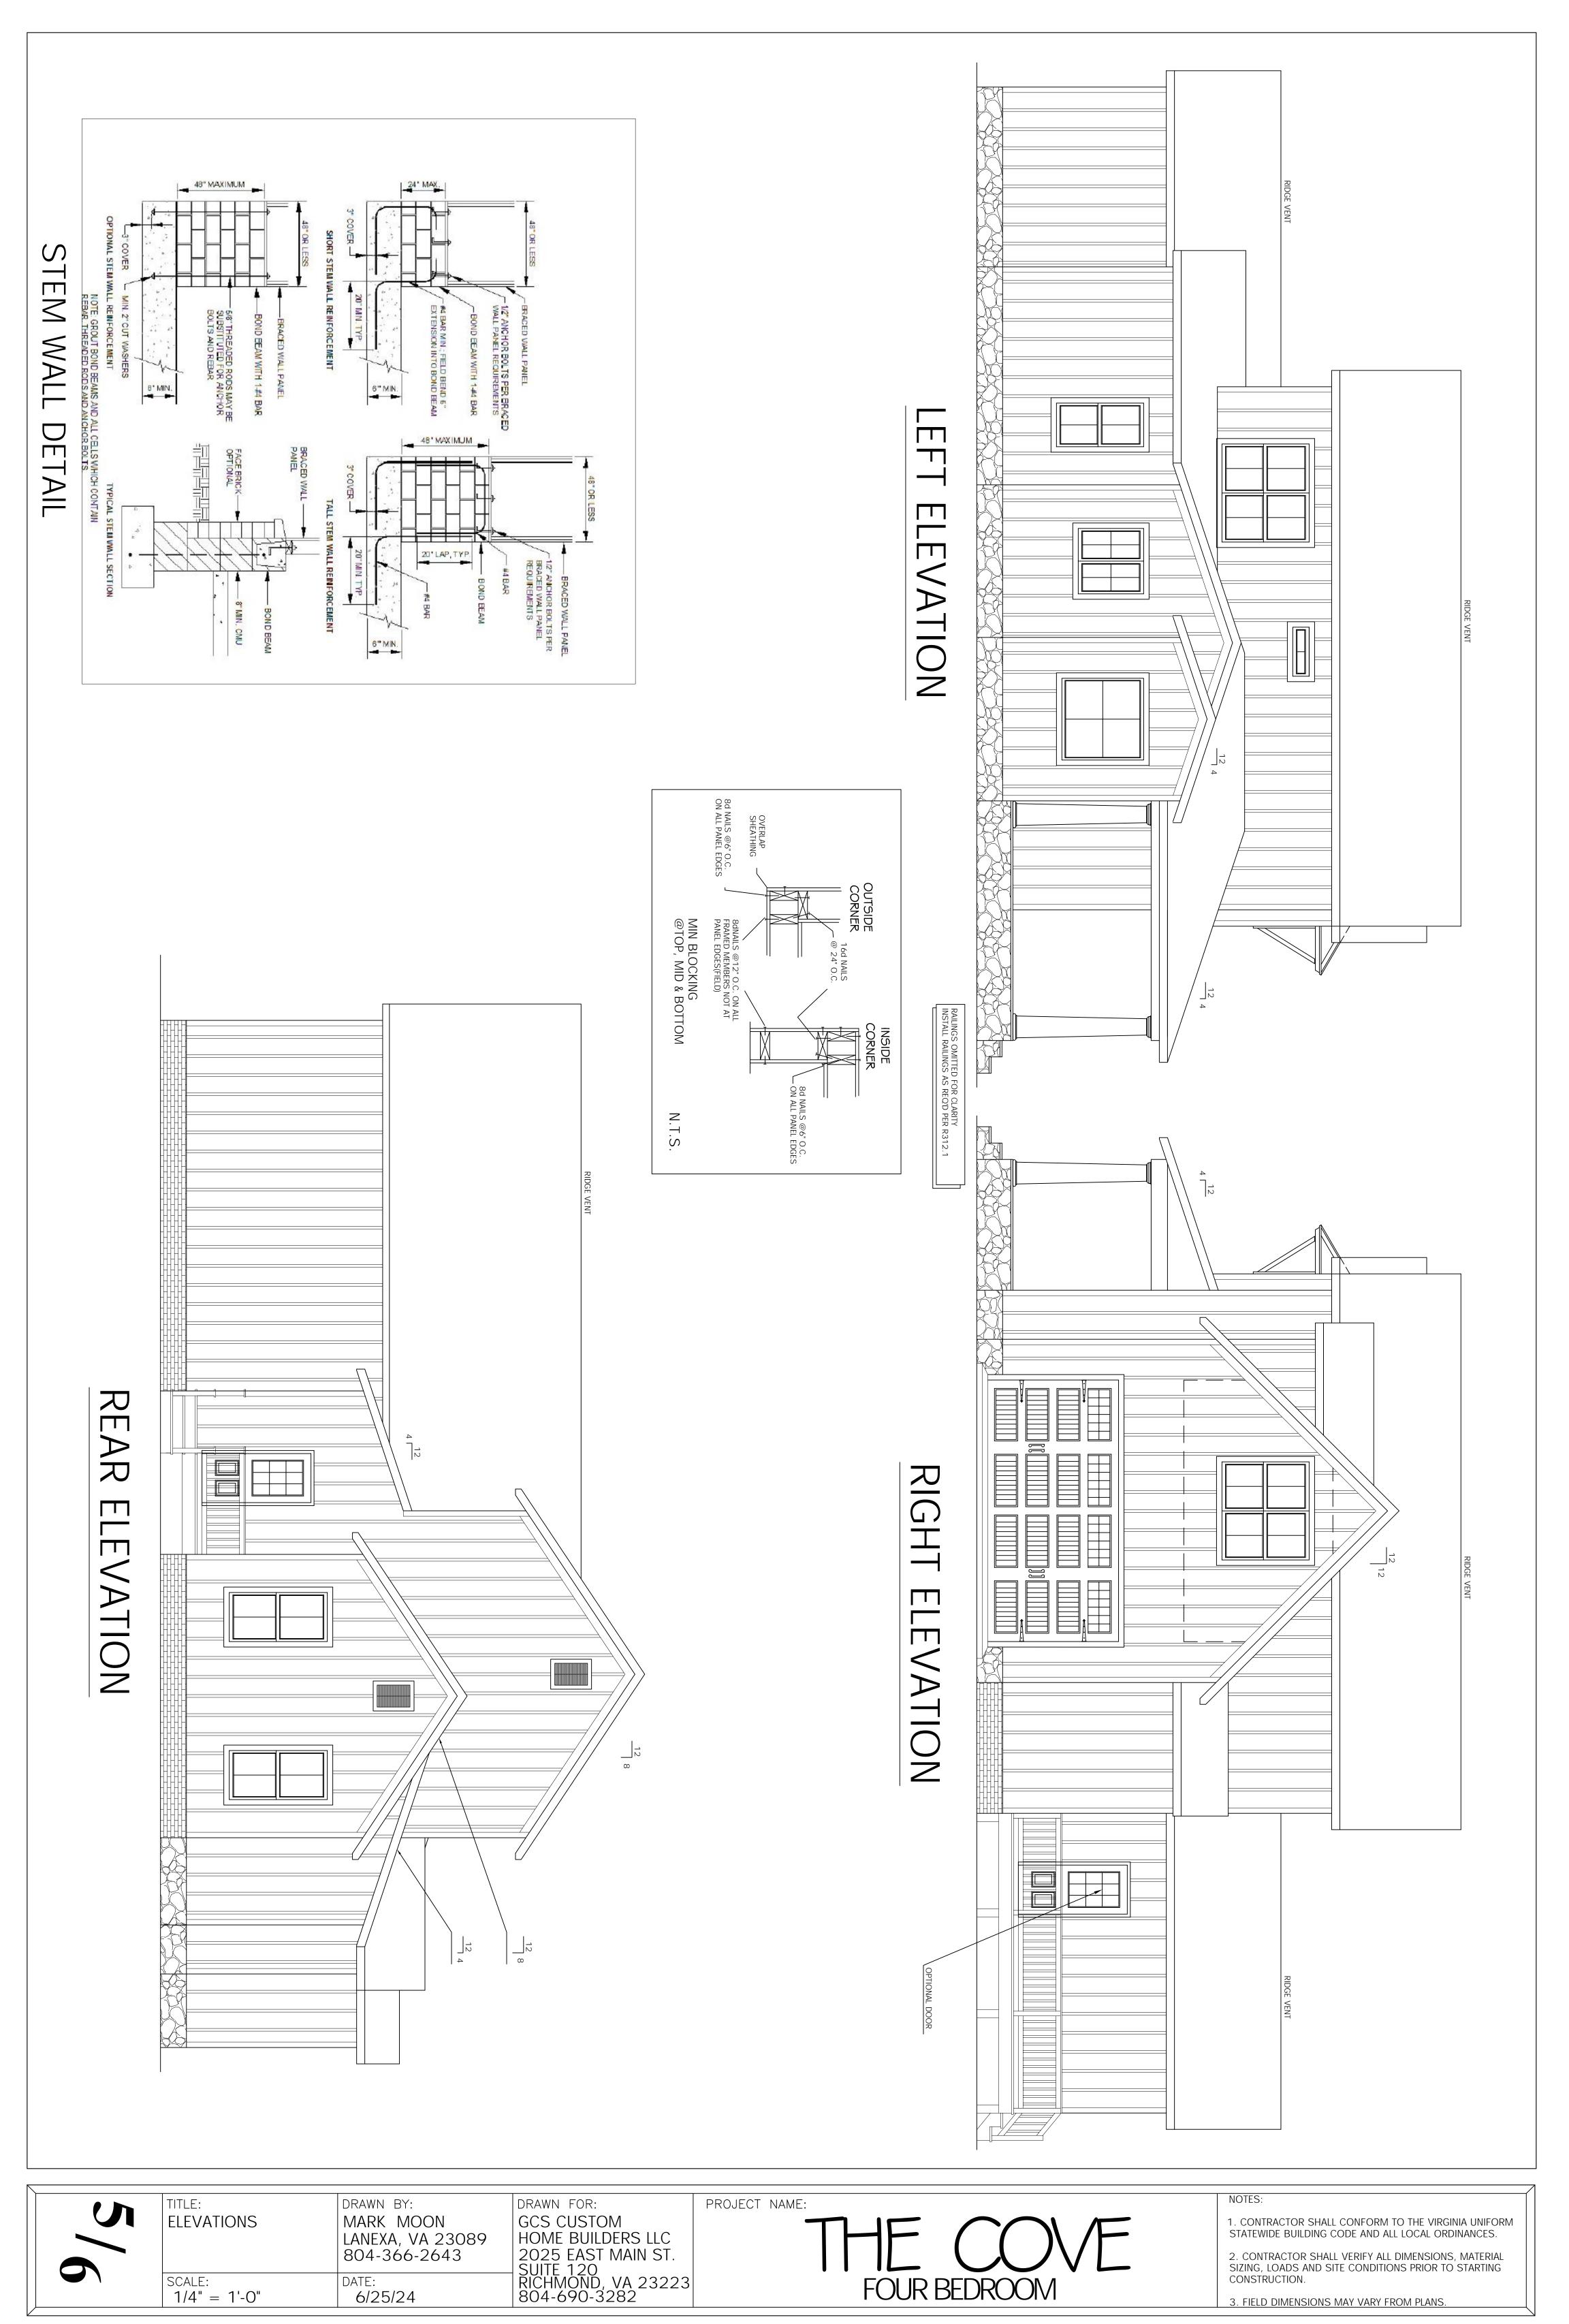





Virginia Practical Wall Bracing Worksheet per 2018 Virginia Residential Code R602.12

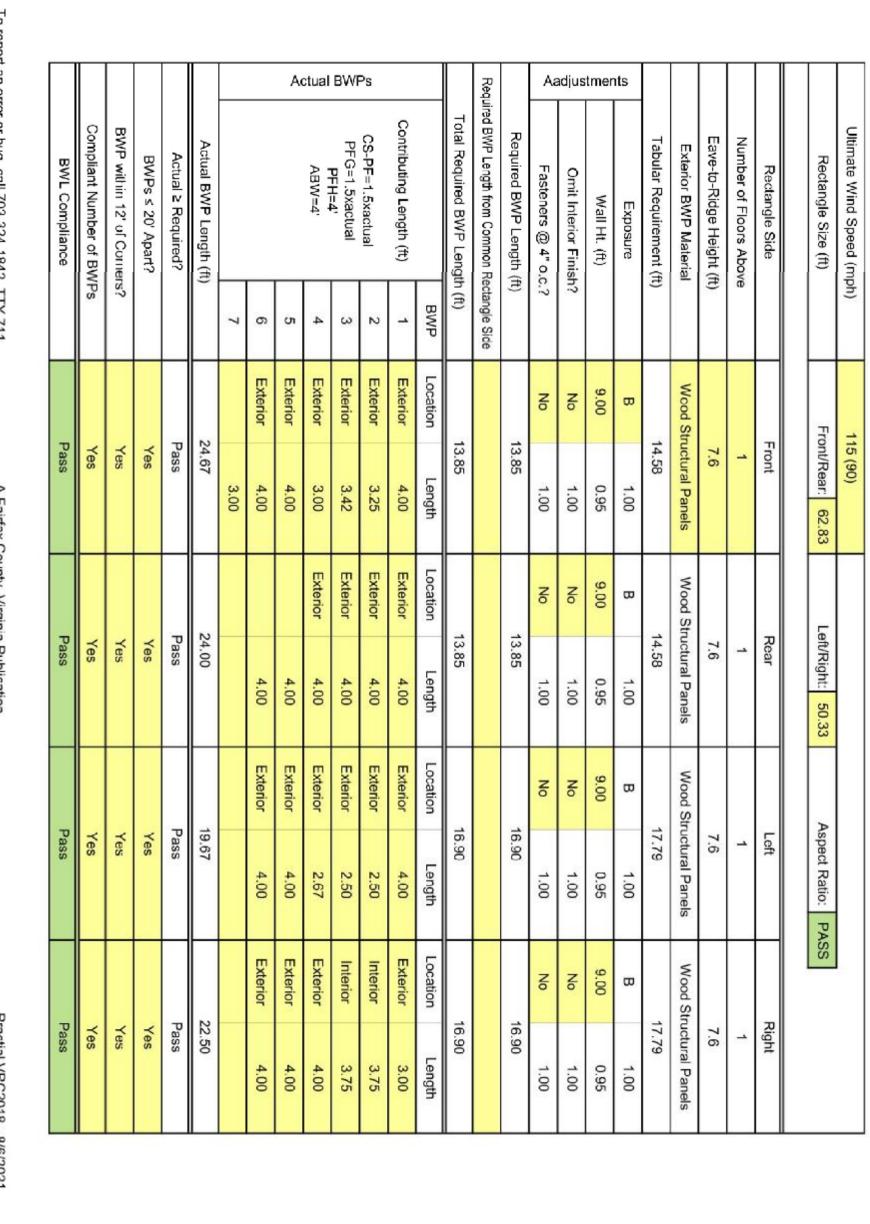

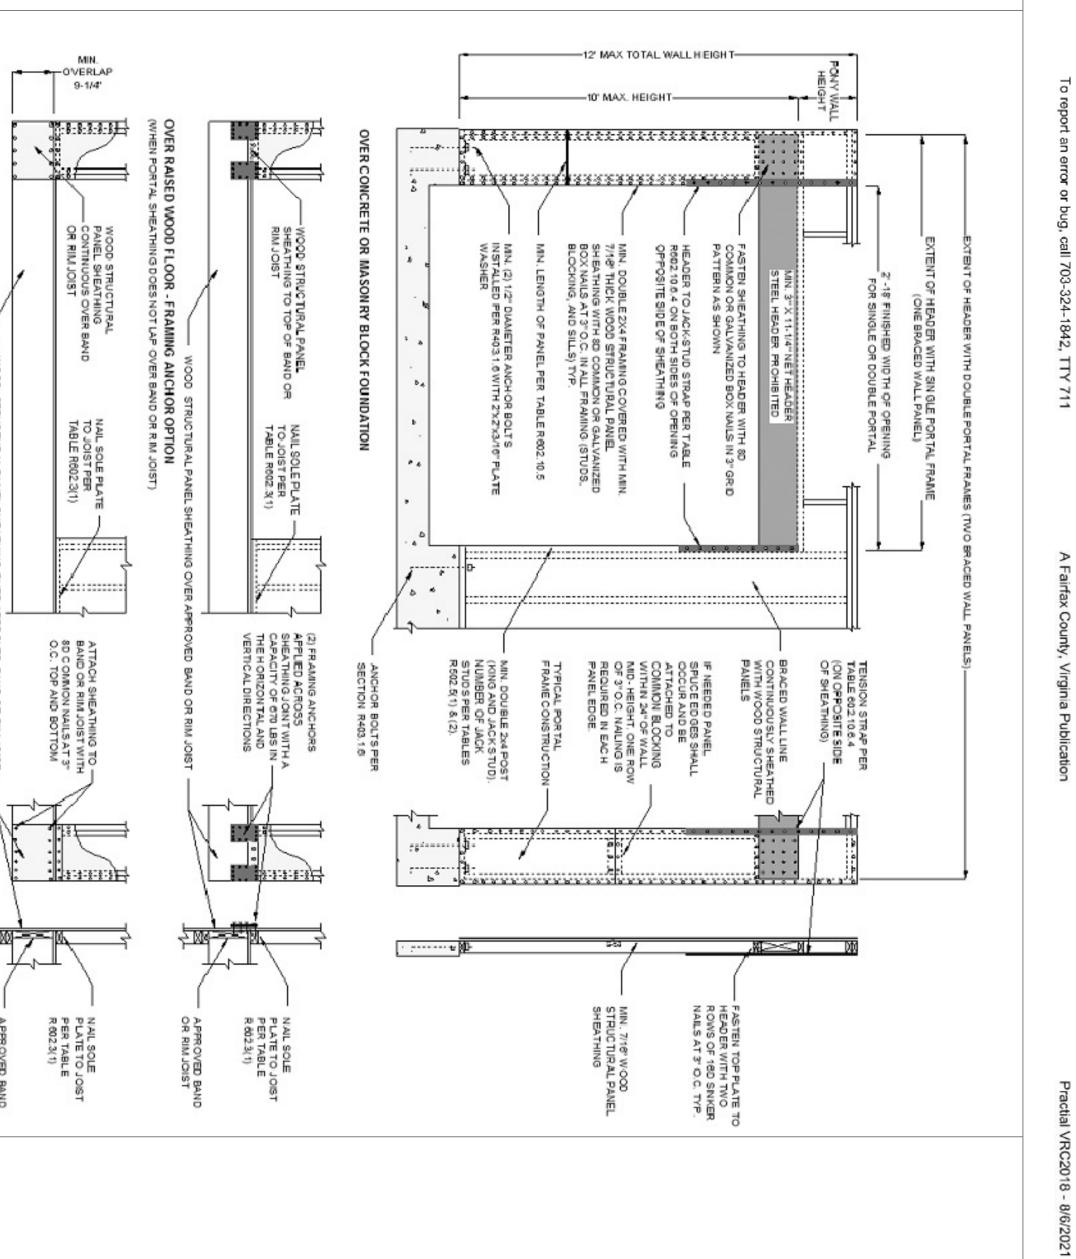

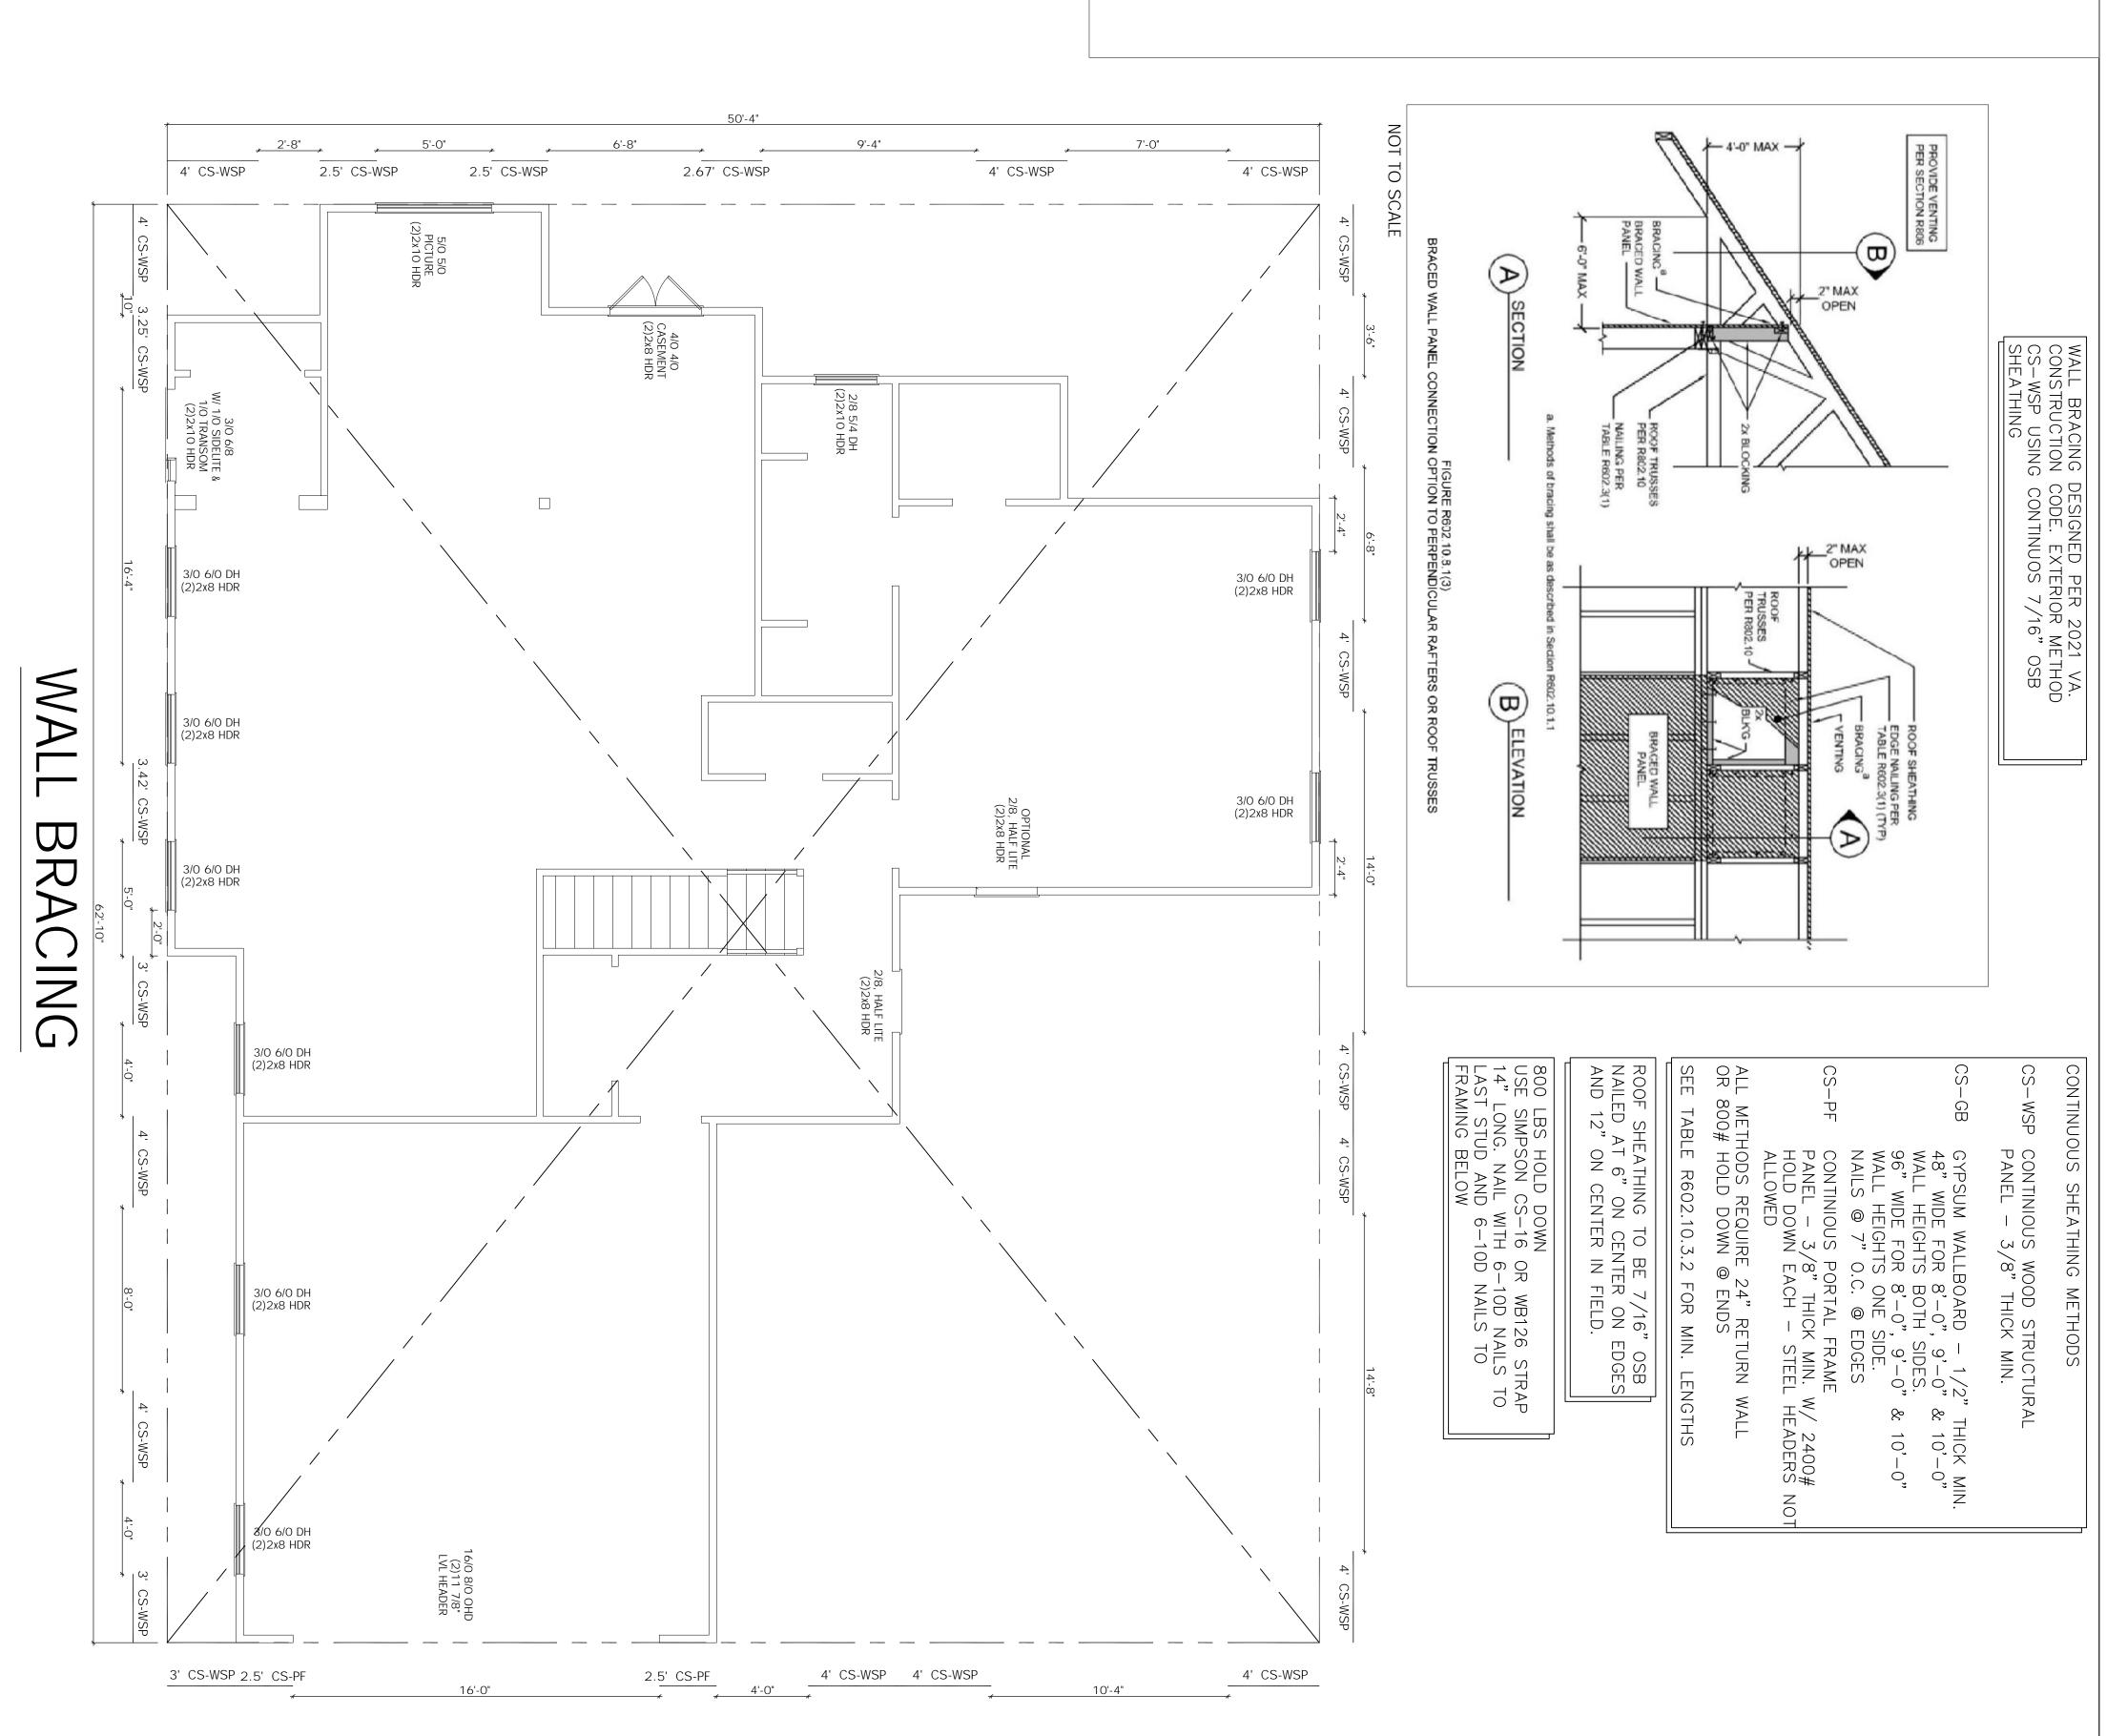

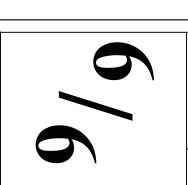

S-PF

PANEL

ONSTRUCTION

(R602

OVER RAISED WOOD FLOOR - OVERLAP OPTION (WHEN PORTAL SHEATHING LAPS OVER BAND OR RIMBOARD)
FRONT ELEVATION

TITLE: WALL BRACING SCALE:

1/4" = 1'-0"

DRAWN BY: MARK MOON LANEXA, VA 23089 804-366-2643 DATE: 6/25/24

DRAWN FOR: GCS CUSTOM HOME BUILDERS LLC 2025 EAST MAIN ST. SUITE 120 RICHMOND, VA 23223 804-690-3282

PROJECT NAME: FOUR BEDROOM NOTES:

1. CONTRACTOR SHALL CONFORM TO THE VIRGINIA UNIFORM STATEWIDE BUILDING CODE AND ALL LOCAL ORDINANCES. 2. CONTRACTOR SHALL VERIFY ALL DIMENSIONS, MATERIAL SIZING, LOADS AND SITE CONDITIONS PRIOR TO STARTING CONSTRUCTION.

3. FIELD DIMENSIONS MAY VARY FROM PLANS