9' 1-1/2" 9' 1-1/2" STANDING SEAM METAL ROOF 12 CLOSED SHUTTERS  $\leftarrow$ EVATI

EXPOSURE OR GUARD RAIL DESIGN LOAD UNINHABITABLE ATTICE WITHOUT STORAGE UNINHABITABLE ATTICE WITH LIMITED STORAGE HABITABLE ATTICE & ATTICE WITH FIXED STAIRS BALCONIES (EXTERIOR) & DECKS SLEEPING ROOMS SNOW LOAD

NOMINAL WIND SPEED

ULTIMATE DESIGN WIND SPEED ROOF LIVE LOAD ROOF DEAD LOAD

DESIGN LOADS:

20 PSF 10 PSF 25 PSF 90 MPH 115 MPH 200 PLF ( 10 PSF 20 PSF 30 PSF 40 PSF 40 PSF (R301.5)

FIRST FLOOR SECOND FLOOR BONUS ROOM GARAGE FRONT PORCH BACK PORCH

2397 1145 454 518 272 185

\$0. \$0. \$0.

FOUNDATIONS
FIRST FLOOR
SECOND FIRST FLOOR
SECOND FIRST FLEV
REAR ELEV
SECTIONS

**ROOF PLAN / PORCH FJ LAYOUTS** 

100400

JDATION / SECTIONS
FLOOR PLAN / SECTION
ND FLOOR PLAN / SECTION
ELEVATIONS
ELEVATIONS

FRONT

ONTENT

SQUARE FOOTAGE

-THESE DRAWINGS ARE DIAGRAMMATIC INTENDED TO OUTLINE GENERAL REQUIREMENTS ONLY AND NOT INTENDED TO BE COMPLETE IN ALL DETAILS. SPECIFIC IMPLEMENTATIONS OF THE PLANS SHALL BE THE RESPONSIBILITY OF THE CONTRACTOR WHO REPRESENTS HE HAS THE SKILLS AND EXPERT KNOWLEDGE TO EXECUTE THE WORK REQUIRED.

-THE CONTRACTOR AND EACH SUBCONTRACTOR SHALL BE REQUIRED TO CHECK AND VERIFY THAT PLANS CON LOCAL ORDINANCES, BUILDING CODES AND MANUFACTURERS RECOMMENDATIONS PRIOR TO BEGINNING WORLD FORM TO ALL REQUIREMENTS AND

THE CONTRACTOR AND EACH SUBCONTRACTOR SHALL CONFORM TO ALL STATE AND LOCAL CODES AND ORDINANCES

-MEASUREMENTS AND WORKING CONDITIONS FOR ALL WORK SHALL BE TAKEN AT THE SITE AND COORDINATED WITH CONNECTIONS WORKS BY EACH SUBCONTRACTOR

-ANY WORK NOT DIRECTLY SHOWN ON THE DRAWINGS OR LISTED IN THE SPECIFICATIONS (IF APPROVED), BUT ARE IMPLIED OR OTHERWISE NORMALLY CONSIDERED PART OR A SUCCESSFUL INSTALLATION, SHALL BE REQUIRED AND CONSIDERED AN INTEGRAL PART OF THIS WORK

-THE CONTRACTOR AND EACH SUBCONTRACTOR SHALL VERIFY ALL SITE CONDITIONS, DIMENSIONS AND DETAILAYING OUT OR PROCEEDING WITH WORK AND SHALL BE HELD ACCOUNTABLE FOR ANY ERROR RESULTING FR VERIFICATION ILS SHOWN IN THE DRAWINGS BEFORE OM FAILURE TO EXERCISE SUCH

-ANY MODIFICATIONS TO THE DRAWINGS OR CHANGES TO THE CONSTRUCTION ON SITE SHALL BE CHECKED FOR AFFECT TO OTHER AREAS AND VERIFIED WITH THE CONTRACTOR BEFORE PROCEEDING WITH THE WORK

THE CONTRACTOR AND EACH SUBCONTRACTOR SHALL FURNISH ALL LABOR, MATERIALS, EQUIPMENT AND SERVICES FOR PROPER INSTALLATION WORK SHALL BE DONE BY SKILLED MECHANICS IN ACCORDANCE WITH THE BEST PRACTICE FOR A SUBSTANTIAL AND COMPLETE JOB

-SOIL BEARING CAPACITY IS ASSUMED TO BE 1500PSF MIN. WITH FOOTING PLACED ON UNDISTURBED EARTH, AND SLAB ON DRY DENSITY

COMPACTED FILL WITH 95

-ALL ENGINEERED LUMBER SUCH AS LAMINATED VENEER LUMBER, ROOF TRUSSES, FLOOR TRUSSES & I-JOIST ARE INDICATED AS STRUCTURAL MEMBERS. CONTRACTOR TO HAVE MANUFACTURER'S REPRESENTATIVE ISSUE CALCULATIONS FOR ALL ENGINEERED LUMBER TO THE BUILDING INSPECTIONS DEPARTMENT UPON APPLICATION OF BUILDING PERMIT

USE PRESSURE TREATED LUMBER BAND BOARD AND SILL PLATE WHERE DECKS, PORCHES AND OTHER APPURTENANCES ARE ATTACHED

-MECHANICAL, ELECTRICAL AND PLUMBING INFORMATION PROVIDED BY OTHERS. THESE TRADES ARE RESPON

SIBLE FOR THEIR OWN PERMITS

-VERIFY THAT FRAMING AND CONSTRUCTION DIMENSIONS ARE COORDINATED WITH SHOP DRAWINGS OF REQUIRED CASEWORK, HVAC EQUIPMENT, BATHTUBS OR OTHER FIXTURES AND EQUIPMENT PRIOR TO CONSTRUCTION, ORDERING AND INSULATION

ROOFING CONTRACTOR TO INSTALL ICE AND WATER SHIELD ON ROOF TO EAVE 2'-0" INSIDE EXTERIOR WALL L

-PROTECT EXISTING CONSTRUCTION FROM DAMAGE RESULTING FROM ANY WORK DONE BY CONTRACTOR OR ANY SUBCONTRACTOR -CONTRACTOR SHALL CAULK, FLASH OR OTHERWISE MAKE THE BUILDING WEATHERTIGHT. SEAL ALL GAPS BETWEEN DISSIMILAR MATERIALS

-EACH SLEEPING ROOM SHALL HAVE AT LEAST ONE WINDOW WITH A MINIMUM NET CLEAR OPENING OF A MINIMUM NET CLEAR WIDTH AND HEIGHT DIMENSIONS OF 20" & 24" RESPECTIVELY. THE SILL HEIGHT STATES OF THE STATES

-BRIDGING AND BLOCKING ON ALL 8'-0" SPANS AND AT MIDPOINTS OF SPANS

-PROVIDE GROUND TREATMENT THROUGHOUT

-ALL EXPOSED DECK & SCREENED PORCH LUMBER TO BE COMPOSITE OR PRESSURE TREATED

-ALL DIMENSIONS ARE ACTUARIAL AND ARE SHOWN FROM FACE OF STUD OR FACE OF MASONRY UNLESS INDICATED OTHERWISE

-INTERIOR PARTITIONS ARE ILLUSTRATED AS 3 ½" WALL STUDS @ 16" O.C. UNLESS IND -EXTERIOR FRAMED PARTITIONS ARE ILLUSTRATED AS 3 ½" WALL STUDS, ½" SHEATHING (4" TOTAL) UNLESS INDICATED OTHERWISE ICATED OTHERWISE

-WOOD ROOF TRUSSES SHALL BE DESIGNED AND MANUFACTURED BY A LOCAL TRUSS REGISTER IN THE COMMONWEALTH OF VIRGINIA. THE TRUSS MANUFACTURER SHALL SUPERVISING ENGINEER TO THE GENERAL CONTRACTOR FOR APPROVAL BEFORE BEGI

DRAWINGS DESIGNED VIRGINIA RESIDENTAL 2021

-SMOKE DETECTORS SHALL BE INTERCONNECTED AND RECEIVE THEIR PRIMARY POWER BY PERMANENT SYSTEM AND WHEN PRIMARY POWER IS INTERRUPTED, SHALL RECEIVE POWER FROM A BATTERY -EXHAUST FAN AND CONDENSATE LINES SHALL BE RUN TO AN APPROVED EXTERIOR DISCHARGE 5.7 SQUARE FEET, FOR GRADE FLOOR WINDOWS SHALL NOT BE GREATER THAN 44" ABOVE FIN.

TITLE: FRONT ELEVATION **NOTES** SCALE:

DRAWN BY: MARK MOON LANEXA, VA 23089 804-366-2643 DATE: 7/18/24 1/4" = 1'-0"

DRAWN FOR: GCS CUSTOM HOME BUILDERS LLC 2025 EAST MAIN ST. SUITE 120 RICHMOND, VA 23223 804-690-3282

PROJECT NAME:


2 CAR GARAGE

ME ANNA

**NOTES** 

 CONTRACTOR SHALL CONFORM TO THE VIRGINIA UNIFORM STATEWIDE BUILDING CODE AND ALL LOCAL ORDINANCES. 2. CONTRACTOR SHALL VERIFY ALL DIMENSIONS, MATERIAL SIZING, LOADS AND SITE CONDITIONS PRIOR TO STARTING **CONSTRUCTION** 

3. FIELD DIMENSIONS MAY VARY FROM PLANS

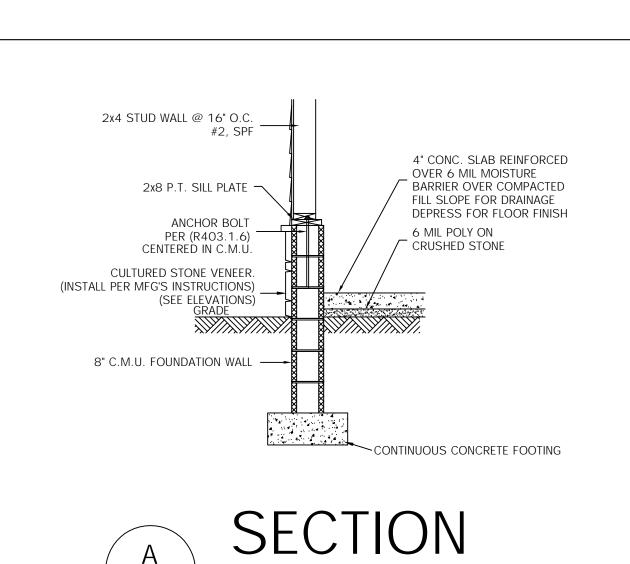


CONCRETE SLAB TO BE 4" THICK, REINFORCED, POURED ON 5 MIL. POLYETHYENE VAPOR BARRIER OVER 4"

OF COMPACTED CRUSHED STONE

GRADE


UNDISTURBED EARTH



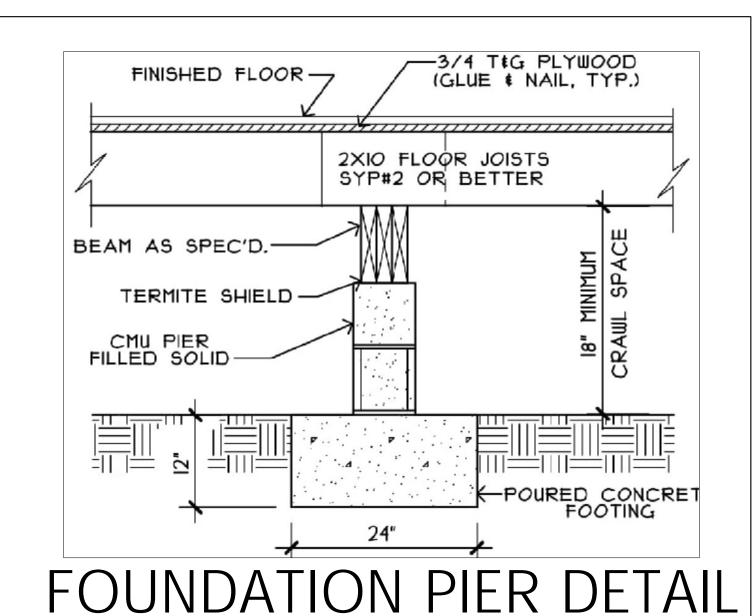

NOT TO SCALE



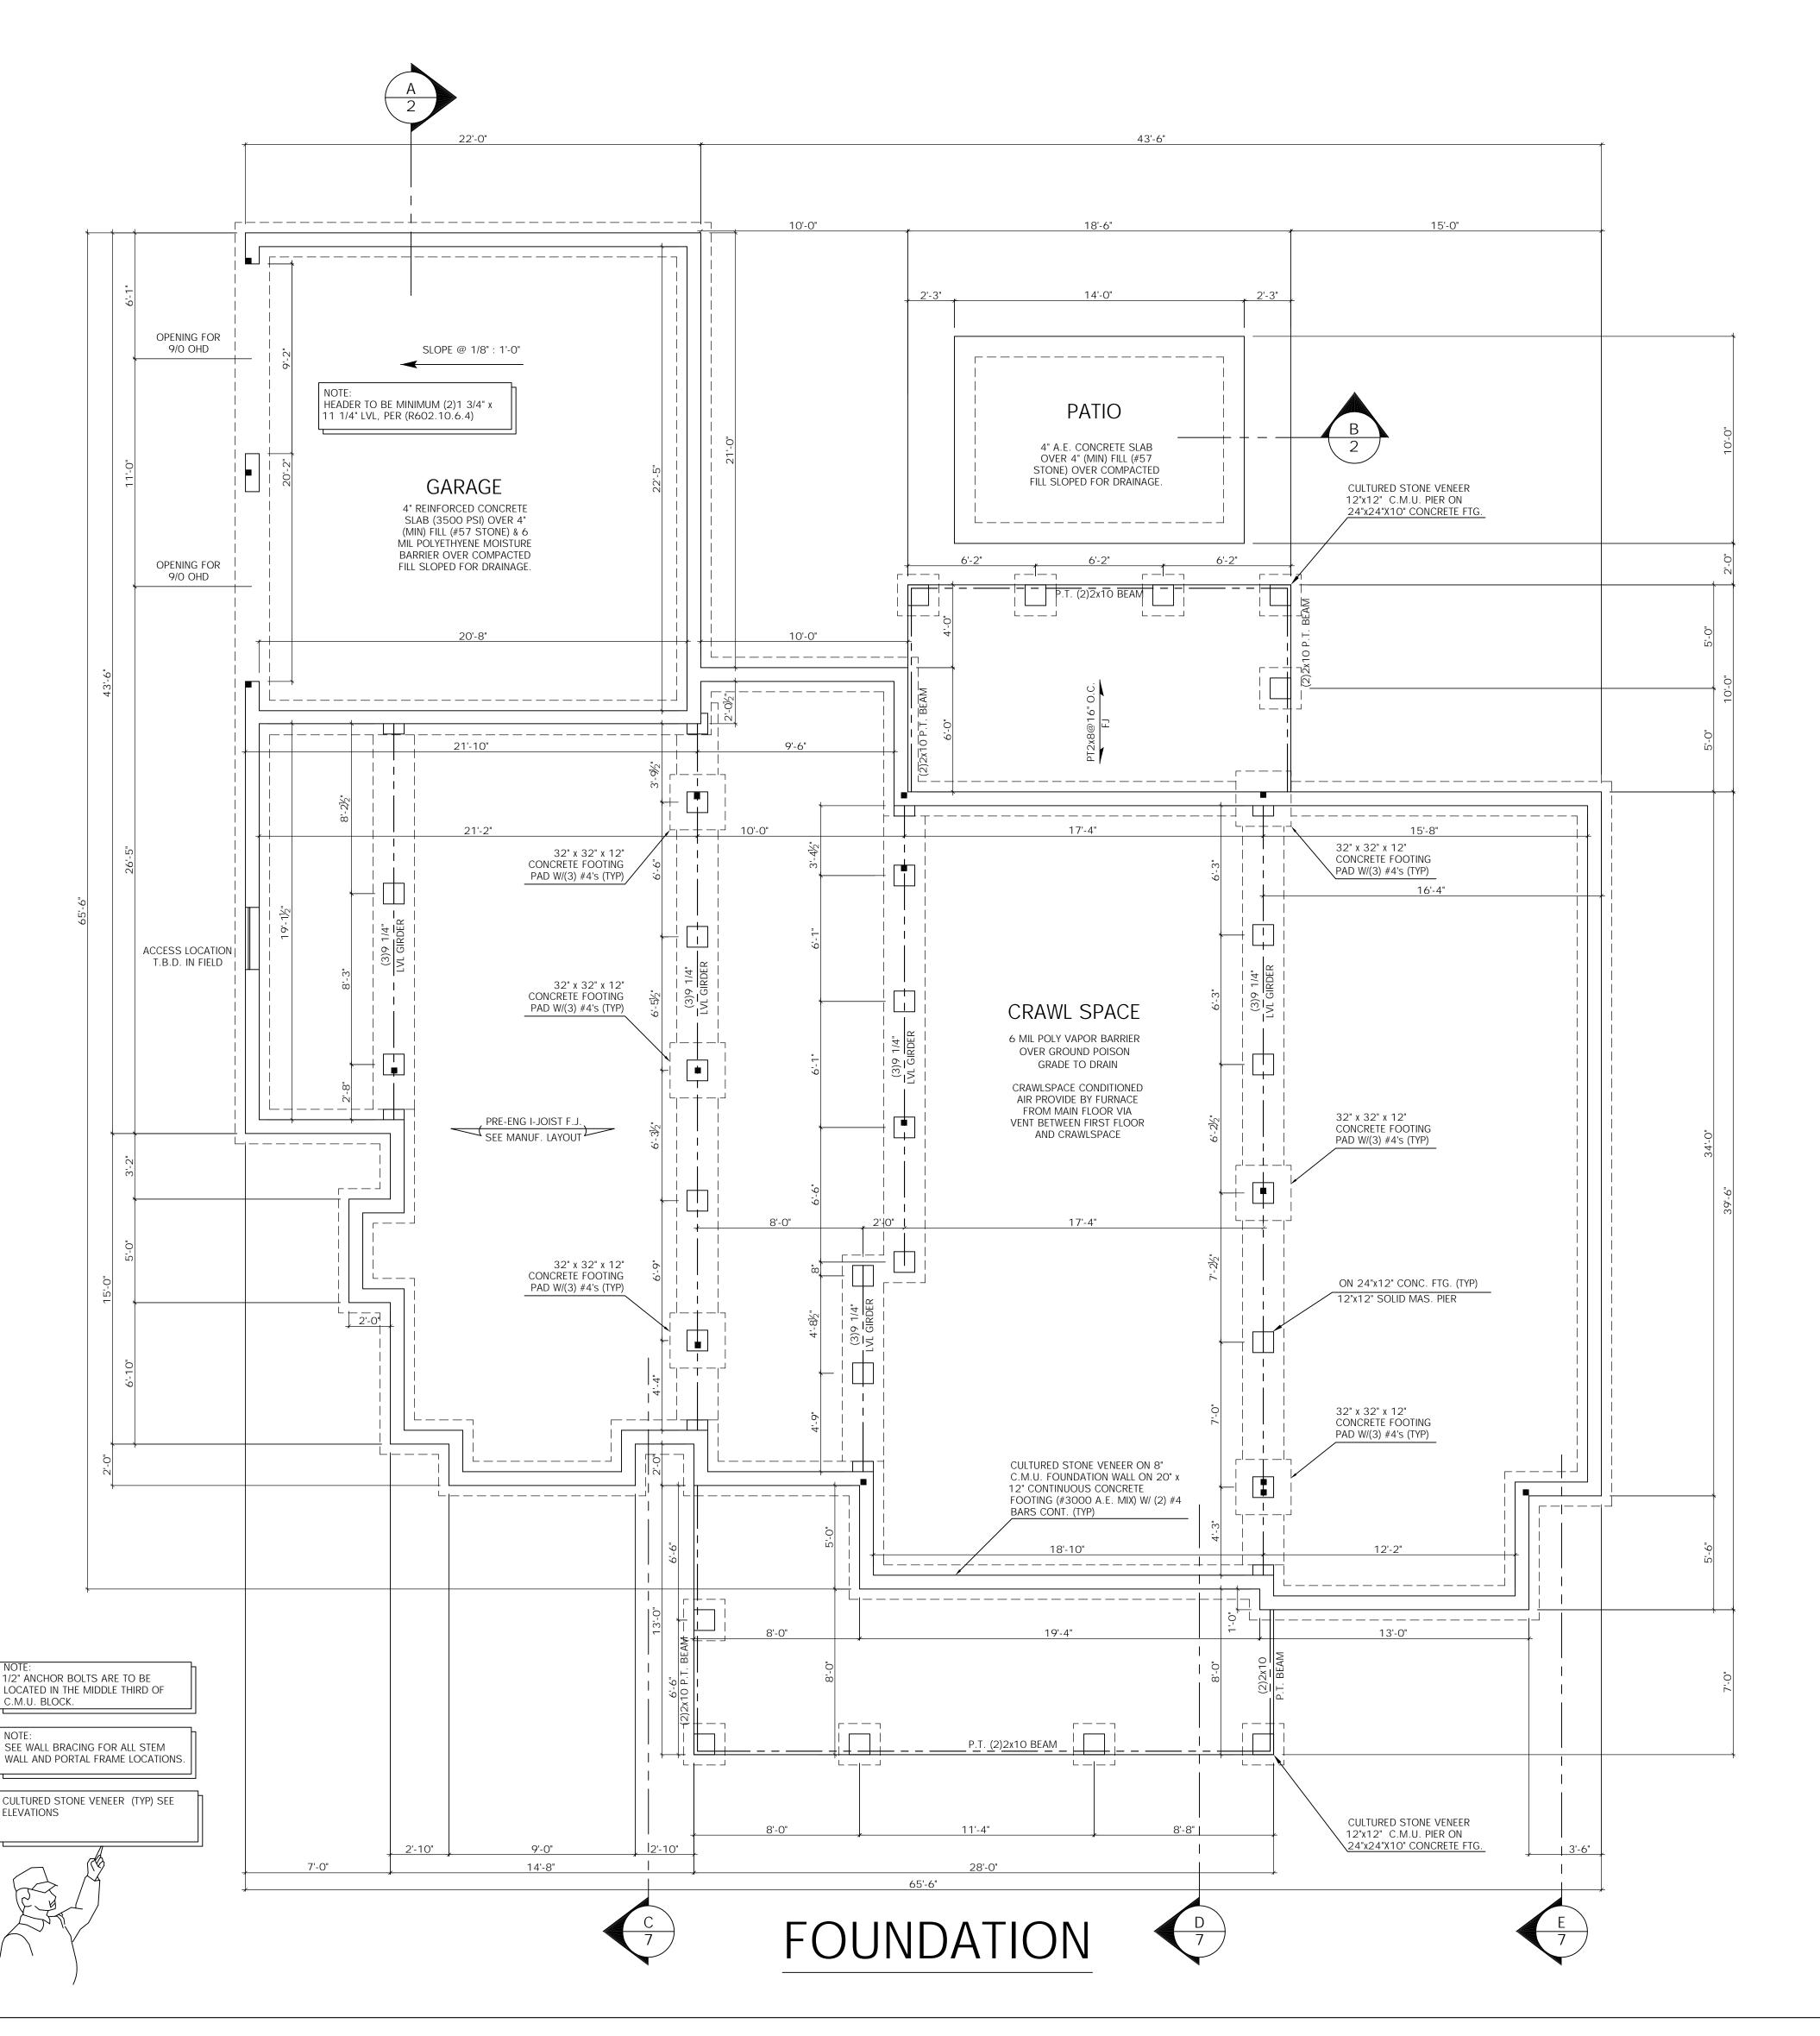

2/7

FOUNDATION SECTION

SCALE:

1/4" = 1'-0"

DRAWN BY:
MARK MOON
LANEXA, VA 23089
804-366-2643

DATE:

7/18/24

DRAWN FOR:
GCS CUSTOM
HOME BUILDERS LLC
2025 EAST MAIN ST.
SUITE 120
RICHMOND, VA 23223
804-690-3282

THE ANNA
2 CAR GARAGE

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## NOTE:

ALL BEAMS SUPPORTED BY #2 SPF STUDS UNLESS NOTED OTHERWISE DIMENSIONS: -INTERIOR TO STUDS, -EXTERIOR TO OUTSIDE OF SHEATHING 2x4 STUDS = 3 1/2", 2x6 STUDS = 5 1/2", 1/2" SHEATHING UNLESS NOTED.


POINT LOAD ZZZZZ - BRICK

**SSSSS - LOAD BEARING WALL** 

EACH 2x4 TO CARRY 2000 LBS. 2x6 TO CARRY 2500 LBS. CHECK BEAM REACTIONS PER MANUF. CALC SHEETS FOR PROPPER AMOUNT OF JACK STUDS TO USE.

COLUMNS - (SCREEN PORCH, FRONT PORCH & DECK) UPLIFT PROTECTION USING BOLTS.

SMOKE DETECTOR LOCATION CARBON MONOXIDE ALARM LOCATION

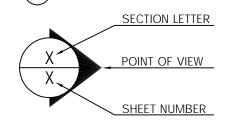


- SMOKE DETECTORS SMOKE DETECTORS INSTALLED IN A NEW DWELLING SHALL BE INTERCONNECTED AND SHALL RECEIVE THEIR PRIMARY POWER BE PERMANENT CONNECTION TO THE DWELLING'S ELECTRICAL SYSTEM AND WHEN PRIMARY POWER IS INTERRUPTED, SHALL RECEIVE POWER FROM A BATTERY.

**EMERGENCY EGRESS** EVERY SLEEPING ROOM SHALL HAVE AT LEAST ONE WINDOW WITH MINIMUM NET CLEAR OPENING OF 5.7 SQ. FT. (5.0 SQ. FT. FOR GRADE FLOOR WINDOWS) WITH A MINIMUM NET CLEAR WIDTH AND HEIGHT DIMENSIONS OF 20" AND 22" RESPECTIVELY. THE SILL HEIGHT SHALL NOT BE GREATER THEN 44".


FIRE EXTINGUISHER WITH RATING OF 2-A:10-B:C TO BE INSTALL IN KITCHEN

ALL FRAMING MATERIAL TO BE #2 SYP OR BETTER, ALL STUDS TO BE SPF OR BETTER, UNLESS NOTED OTHERWISE

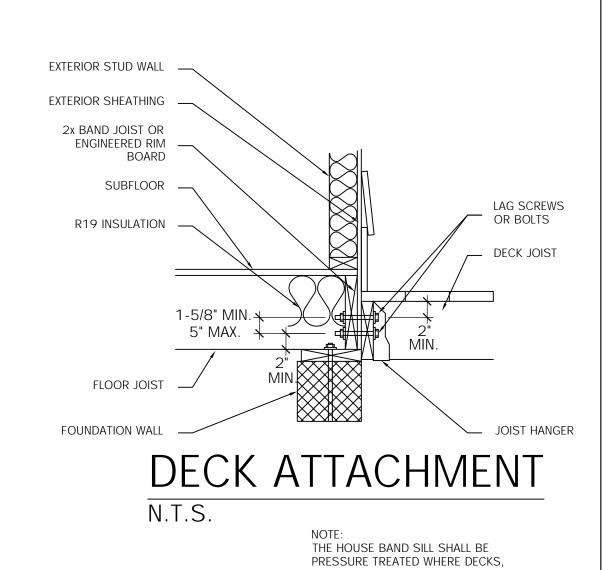

PORCHES AND OTHER APPURTENANCES

ARE ATTACHED

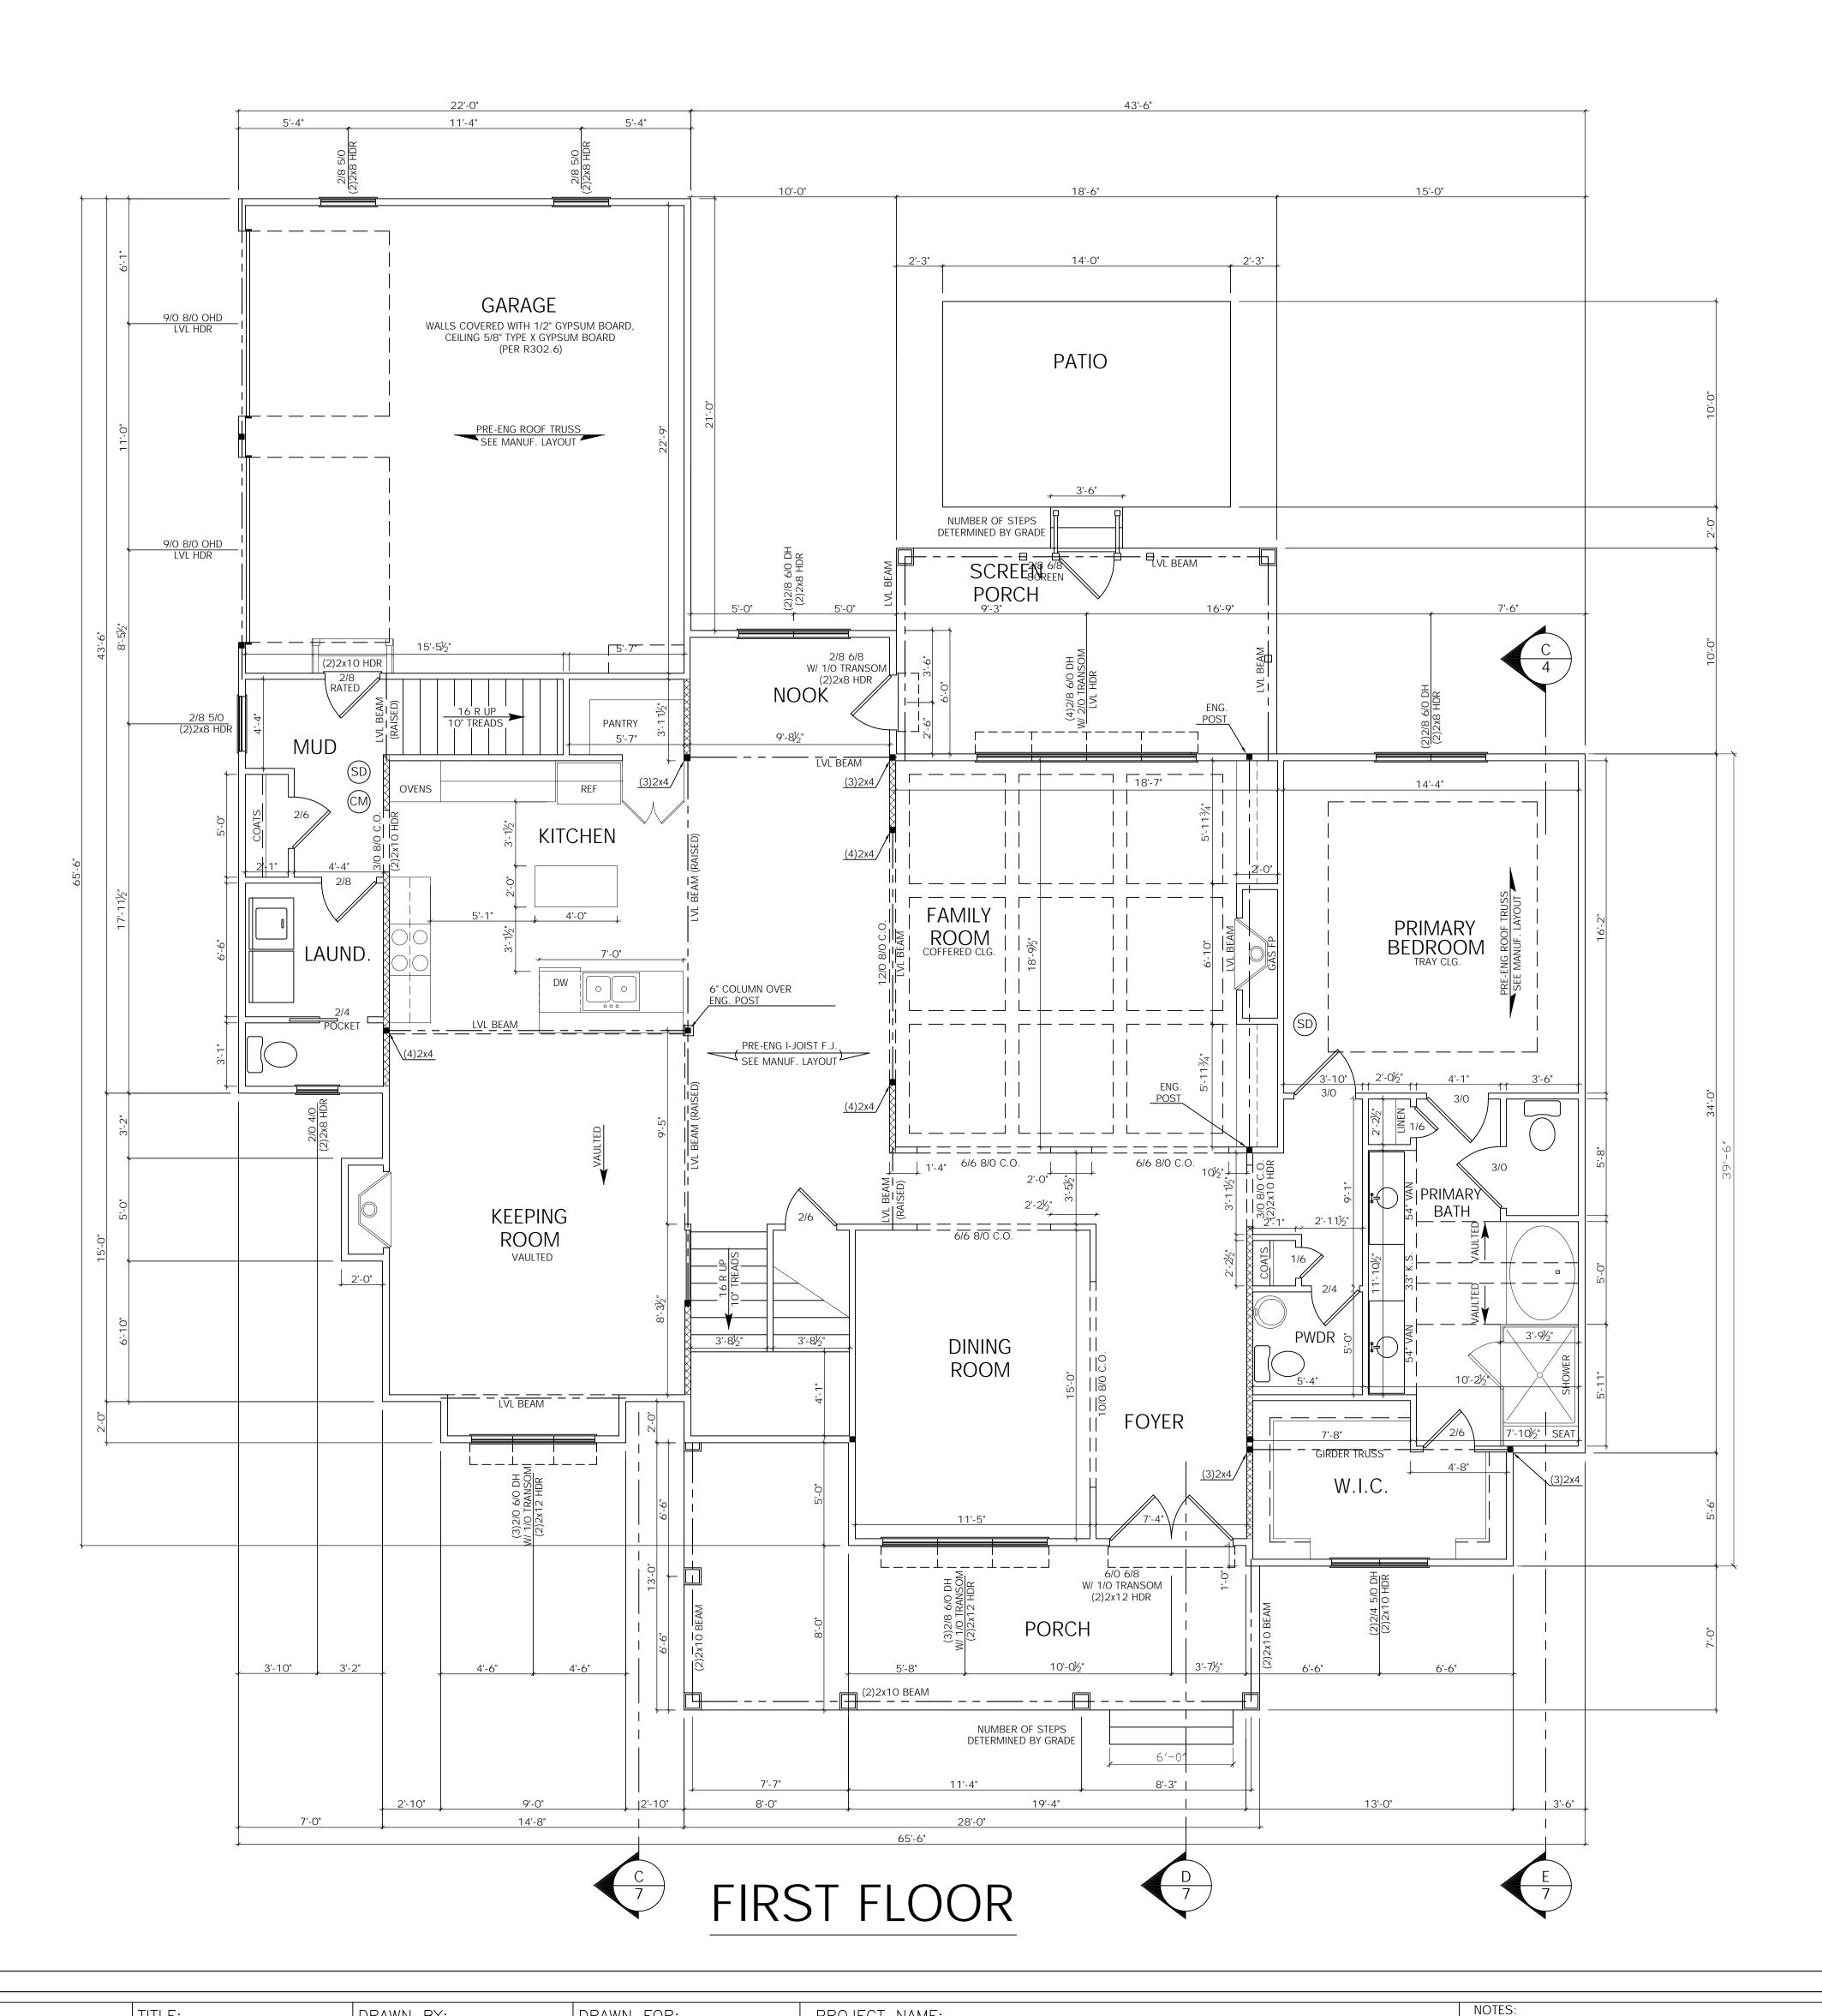

DRAWN BY:


DRAWN FOR: GCS CUSTOM HOME BUILDERS LLC 2025 EAST MAIN ST. SUITE 120 RICHMOND, VA 23223 804-690-3282 PROJECT NAME: THE ANNA
2 CAR GARAGE


1. CONTRACTOR SHALL CONFORM TO THE VIRGINIA UNIFORM STATEWIDE BUILDING CODE AND ALL LOCAL ORDINANCES. 2. CONTRACTOR SHALL VERIFY ALL DIMENSIONS, MATERIAL SIZING, LOADS AND SITE CONDITIONS PRIOR TO STARTING


3. FIELD DIMENSIONS MAY VARY FROM PLANS

CONSTRUCTION.

TITLE:

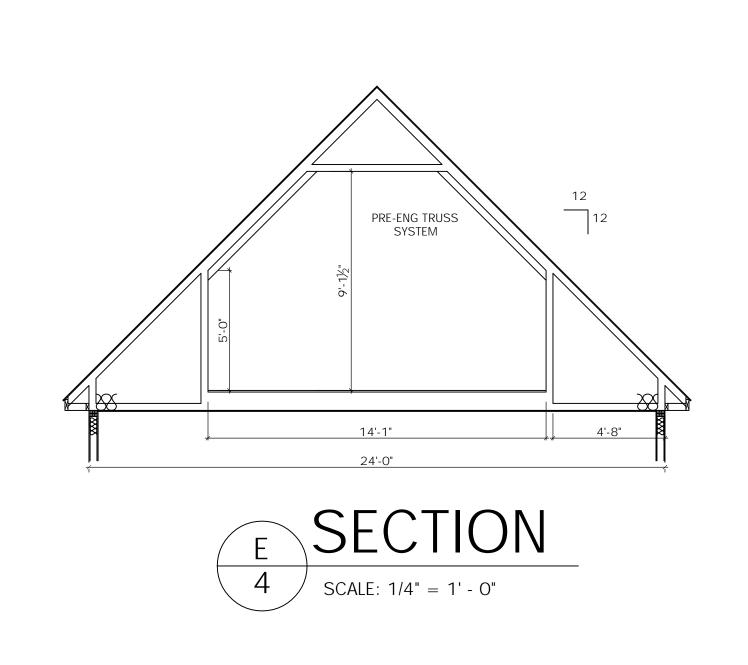

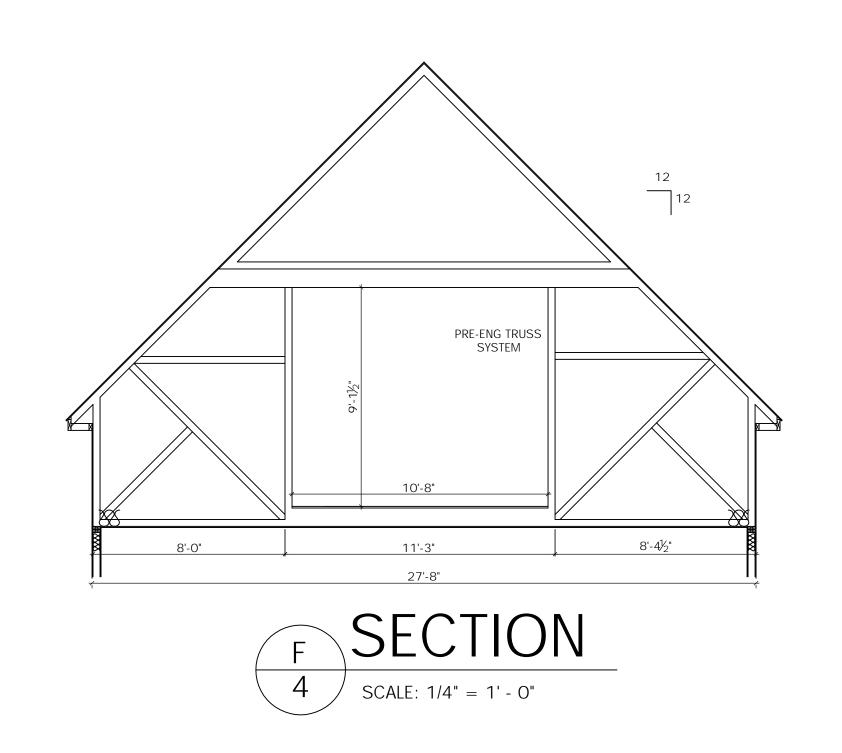

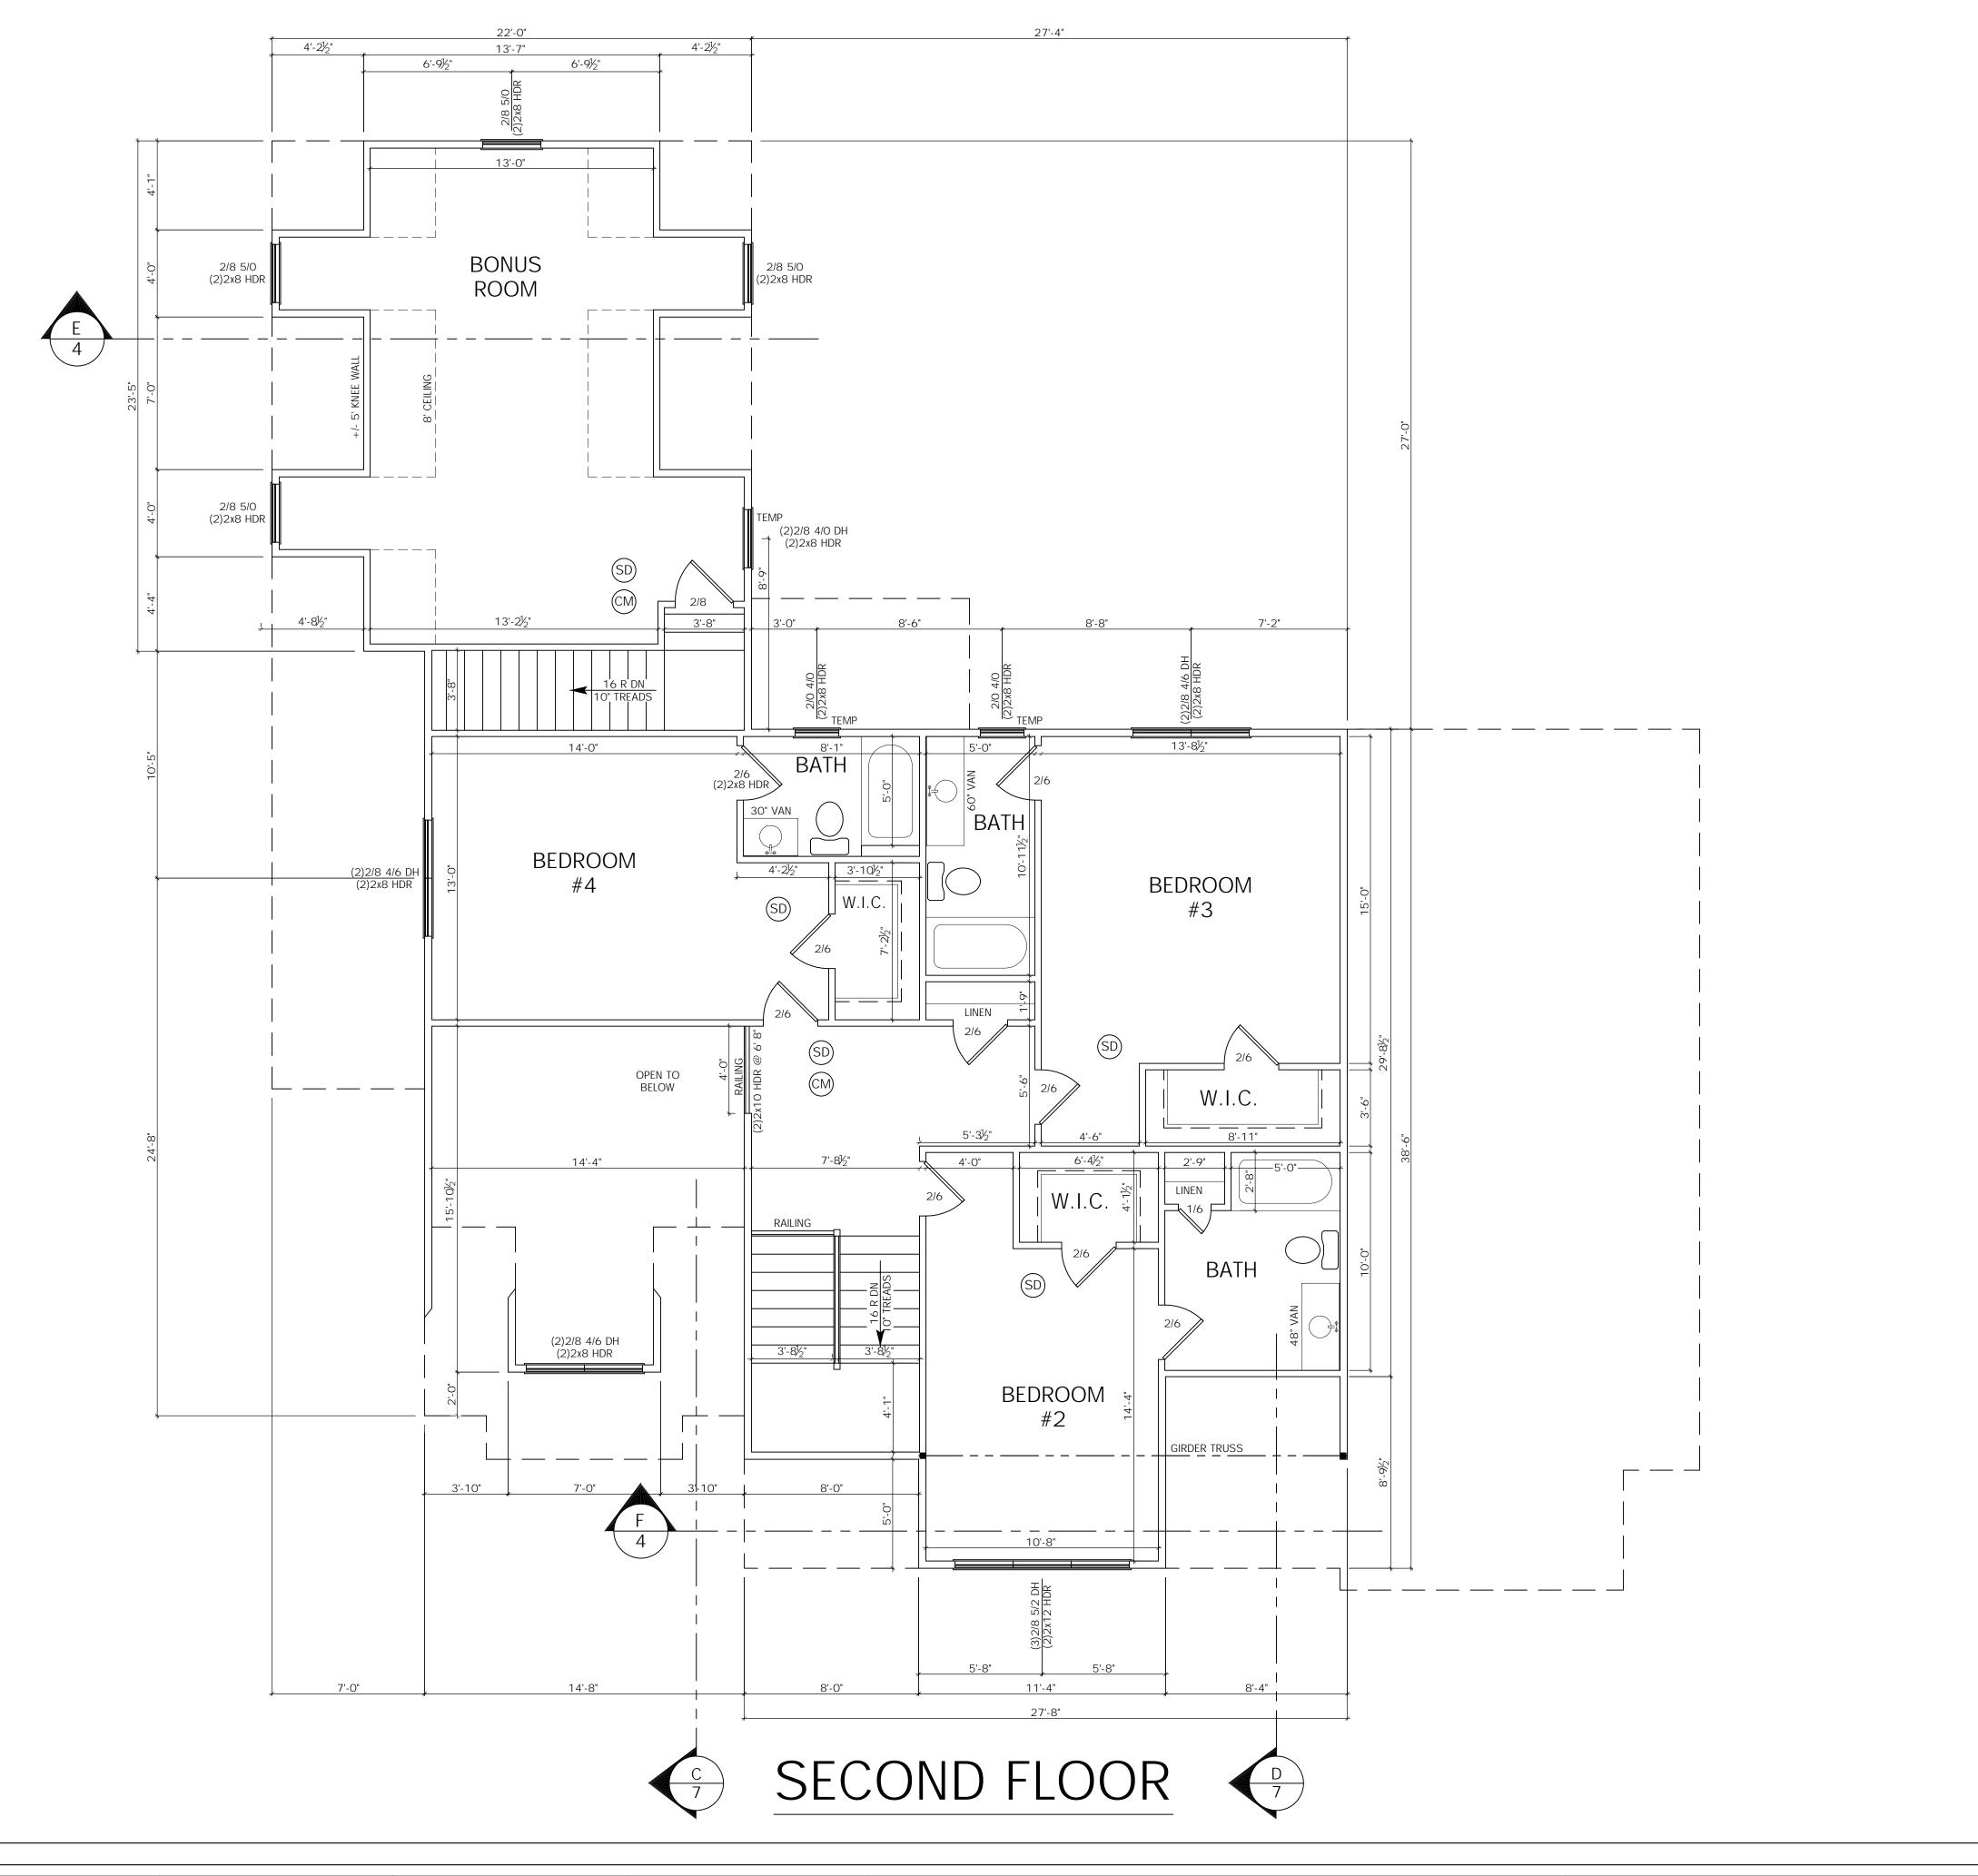



TITLE: DRAWN BY:

SECOND FLOOR
SECTION

SECTION

SCALE: DATE: 7/18/24

DRAWN FOR:
GCS CUSTOM
HOME BUILDERS LLC
2025 EAST MAIN ST.
SUITE 120
RICHMOND, VA 23223
804-690-3282

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